SITE DEVELOPMENT PLAN

PREPARED FOR

SUNFOX CAMPGROUND, LLC

15 KENYON ROAD LISBON, CONNECTICUT FEBRUARY 14, 2022

CIVIL DRAWING INDEX			
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PROPERTY OWNER: SUNFOX CAMPGROUND, LLC 15 KENYON ROAD

LISBON, CONNECTICUT 06351

APPLICANT: SUNFOX CAMPGROUND, LLC

15 KENYON ROAD LISBON, CONNECTICUT 0635

ZONING DISTRICT: R-60

EXISTING USE: CAMPGROUND


PROPOSED USES: CAMPGROUND





PROPERTIES	WITHIN 500'	
ADDRESS	OWNER	
0 KENYON RD	JEWETT CITY WATER COMPANY	
3 KENYON ROAD	WELDON E FRENCH	
5 KENYON ROAD	SUNFOX CAMPGROUND LLC	
9 KENYON ROAD	HECTOR N MARIEN	
10 KENYON RD	PETER G PISOWLOSKI	
13 KENYON RD	CHRISTINE BRANCO HEALY	
19 KENYON ROAD	JEFFREY T RECK	
20 KENYON ROAD	JOHN PAUL & DAWN COUGHLIN	
22 KENYON ROAD	SUNFOX CAMPGROUND LLC	
23 KENYON ROAD	ROBERT RICHMAN	
20 STRNAD ROAD	JEFFREY T BUCKRIDGE	
21 STRNAD ROAD	DAVID L SCOTT	
24 STRNAD ROAD	MICHAEL P THOMAS	
25 STRNAD ROAD	PAMELA COTE	
26 STRNAD ROAD	MICHAEL F HYDE	
27 STRNAD ROAD	DANIELLE BERRIOS	
29 STRNAD ROAD	MAHLON D CURRIER Jr.	
30 STRNAD ROAD	AMANDA CARON	
31 STRNAD ROAD	TIMOTHY R PHILBRICK	
32 STRNAD ROAD	KENNETH A LU WOHLLEBEN, BRIAN K WOHLLEBEN, & WENDY A SNAY	
33 STRNAD ROAD	DAWN A COMBIES	
117 SOUTH BURNHAM HIGHWAY	STILLY'S HOLDINGS LLC	
125 SOUTH BURNHAM HIGHWAY	ENRICO & SUSAN COVINO	
129 SOUTH BURNHAM HIGHWAY	ENRICO & SUSAN S COVINO	
143 SOUTH BURNHAM HIGHWAY	PERFECT PROPERTY LLC	
174 SOUTH BURNHAM HIGHWAY	RICHARD M CZIKOWSKY	
215 SOUTH BURNHAM HIGHWAY	RICHARD ALLEN STRNAD	
29 KENDALL ROAD	WILLIAM C SURFUS	
37 KENDALL ROAD	DONNA M & STEPHEN E JOHN	
49 KENDALL ROAD	SALLY A KNOLHOFF	
55 KENDALL ROAD	ROBERT L LACHAPELLE	
77 KENDALL ROAD	SUNFOX CAMPGROUND LLC	
78 KENDALL ROAD	TOWN OF LISBON	
72 PRESTON ALLEN ROAD	MACY L MERRY & CAITLIN E MONTELLA	
84 PRESTON ALLEN ROAD	ROBERT T BROWN	
86 PRESTON ALLEN ROAD	MICHALE W ROLFE	
90 PRESTON ALLEN ROAD	CHRISTINE KNOGHT	
94 PRESTON ALLEN ROAD	SHARON K LU GLEASON	
128 PRESTON ALLEN ROAD	SANDRA L EDMOND	
144 PRESTON ALLEN ROAD	GARY MOLOCHKO	
23 MELL ROAD	JOHN F ALGIERE	





	PROVED BY TH ING & ZONING	
APPLICATION:		
APPROVED ON:		
CHAIRMAN OR S	SECRETARY SIGNATURE	DATE

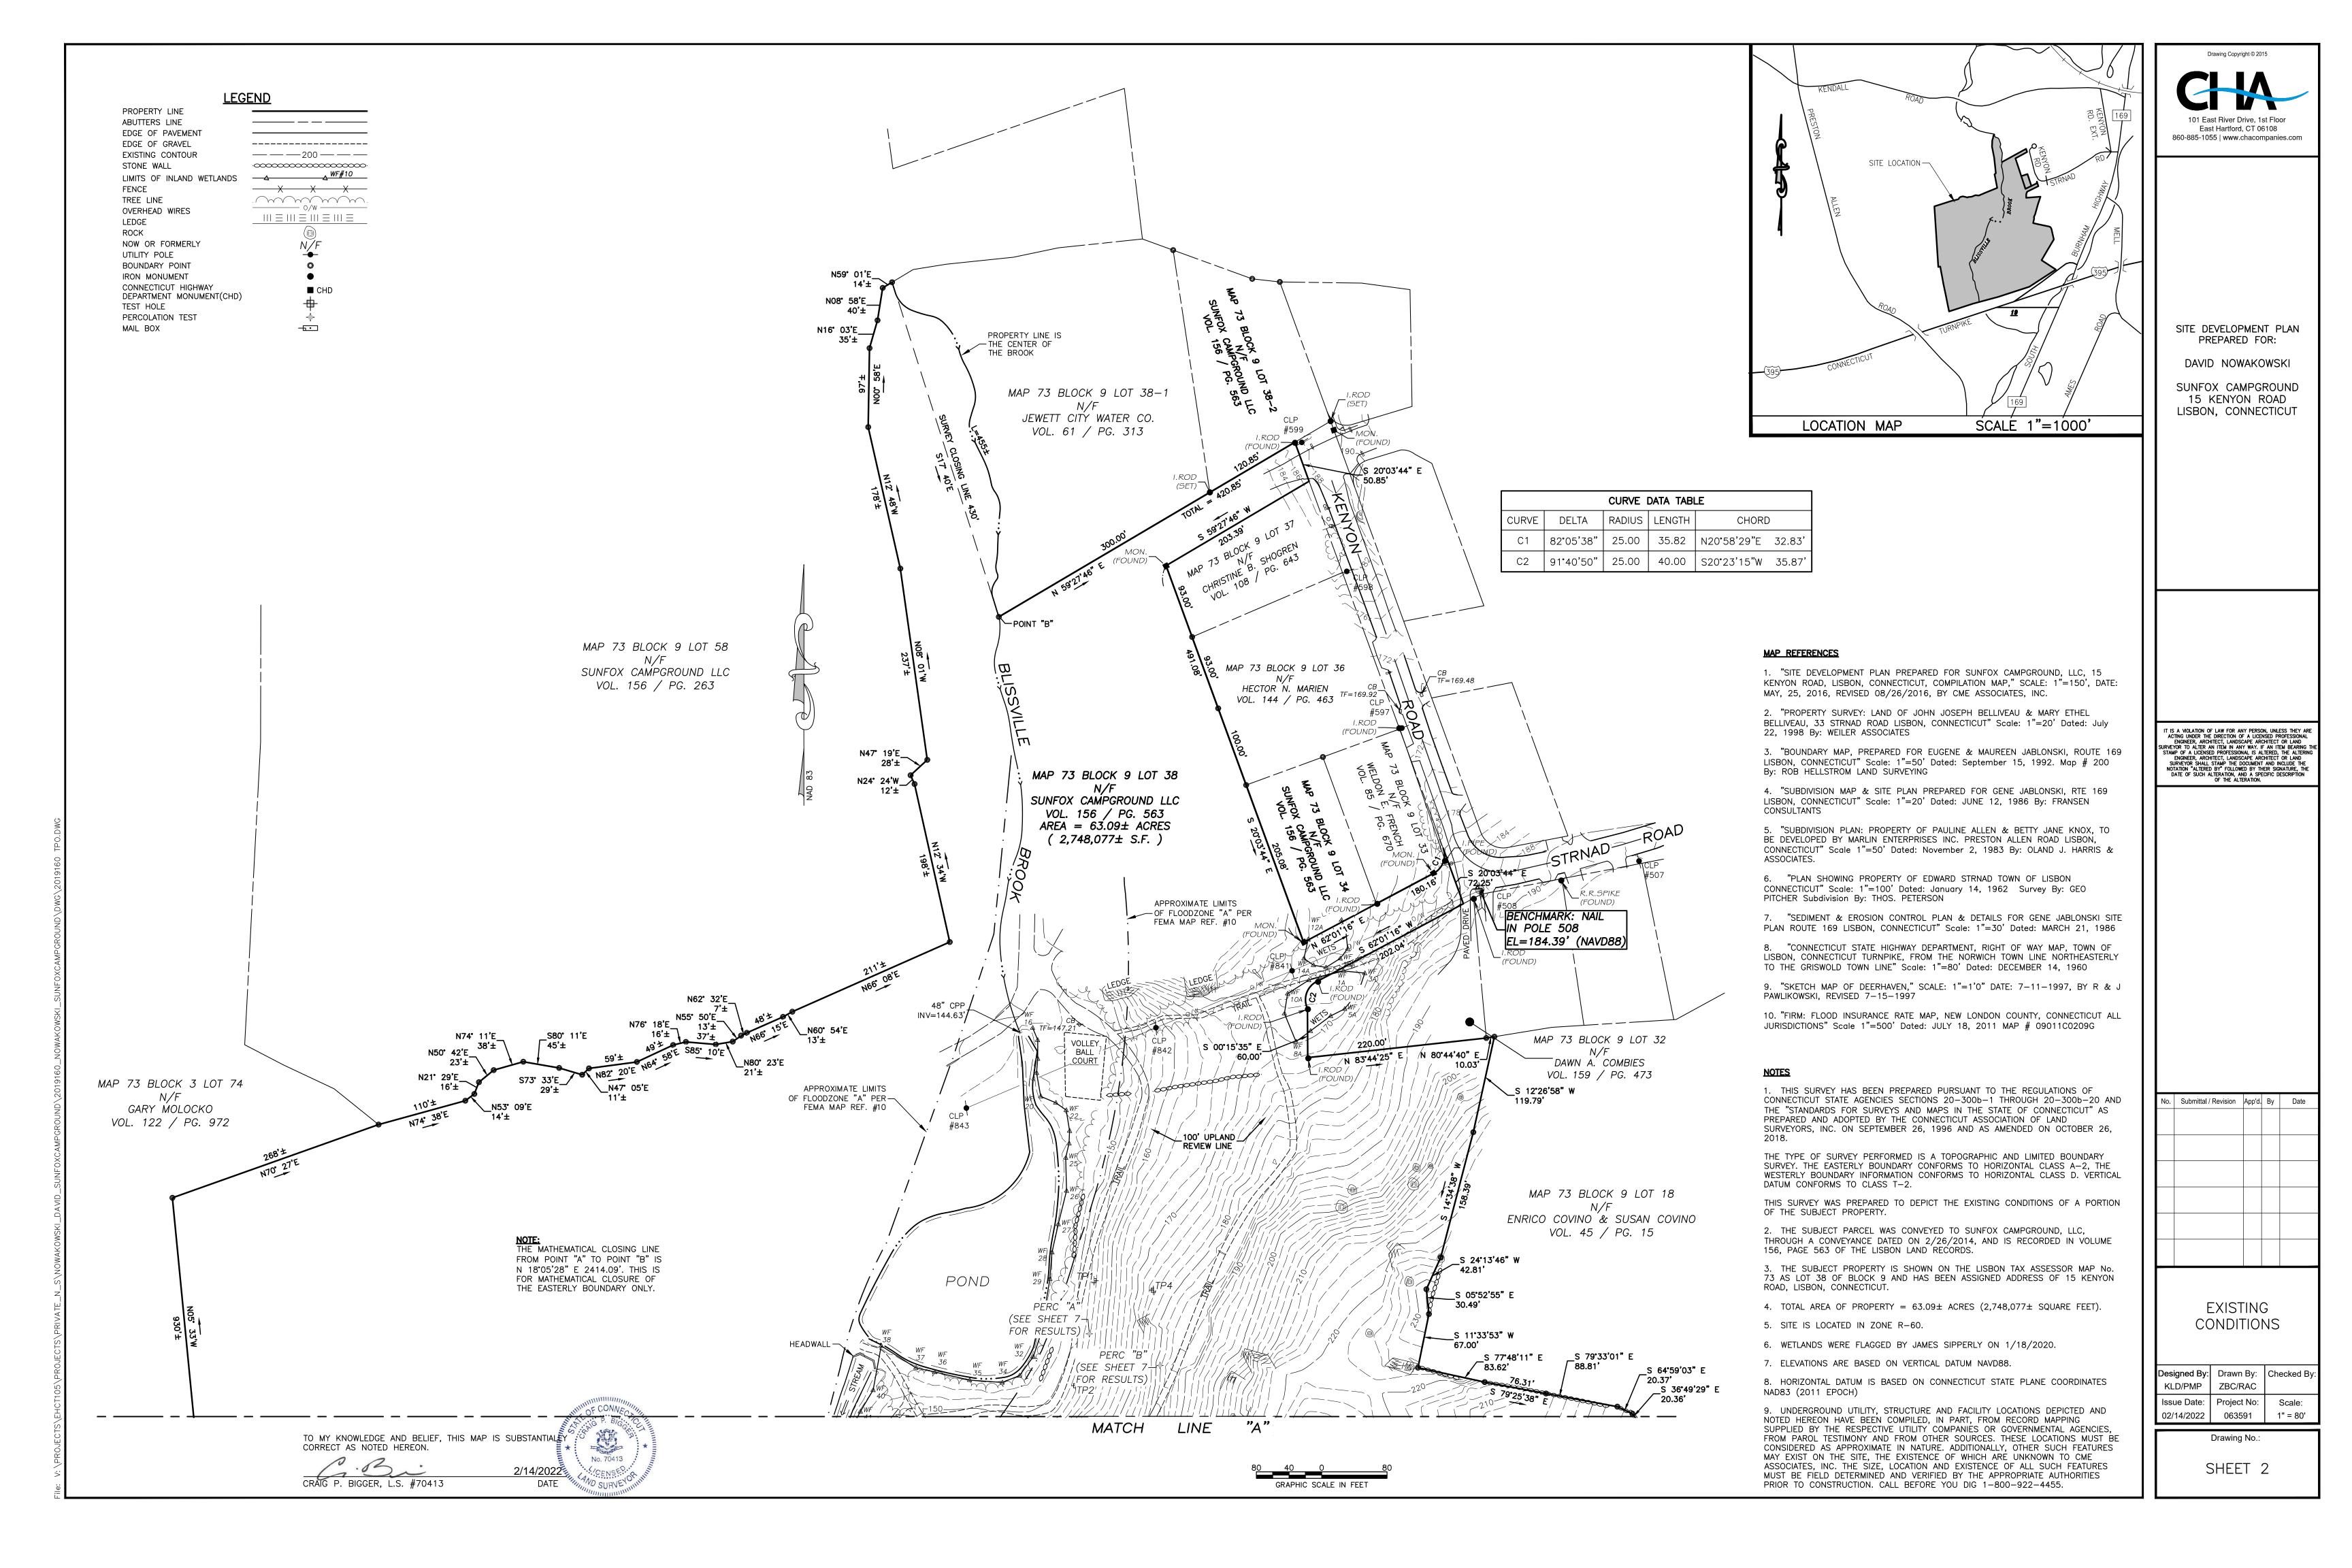


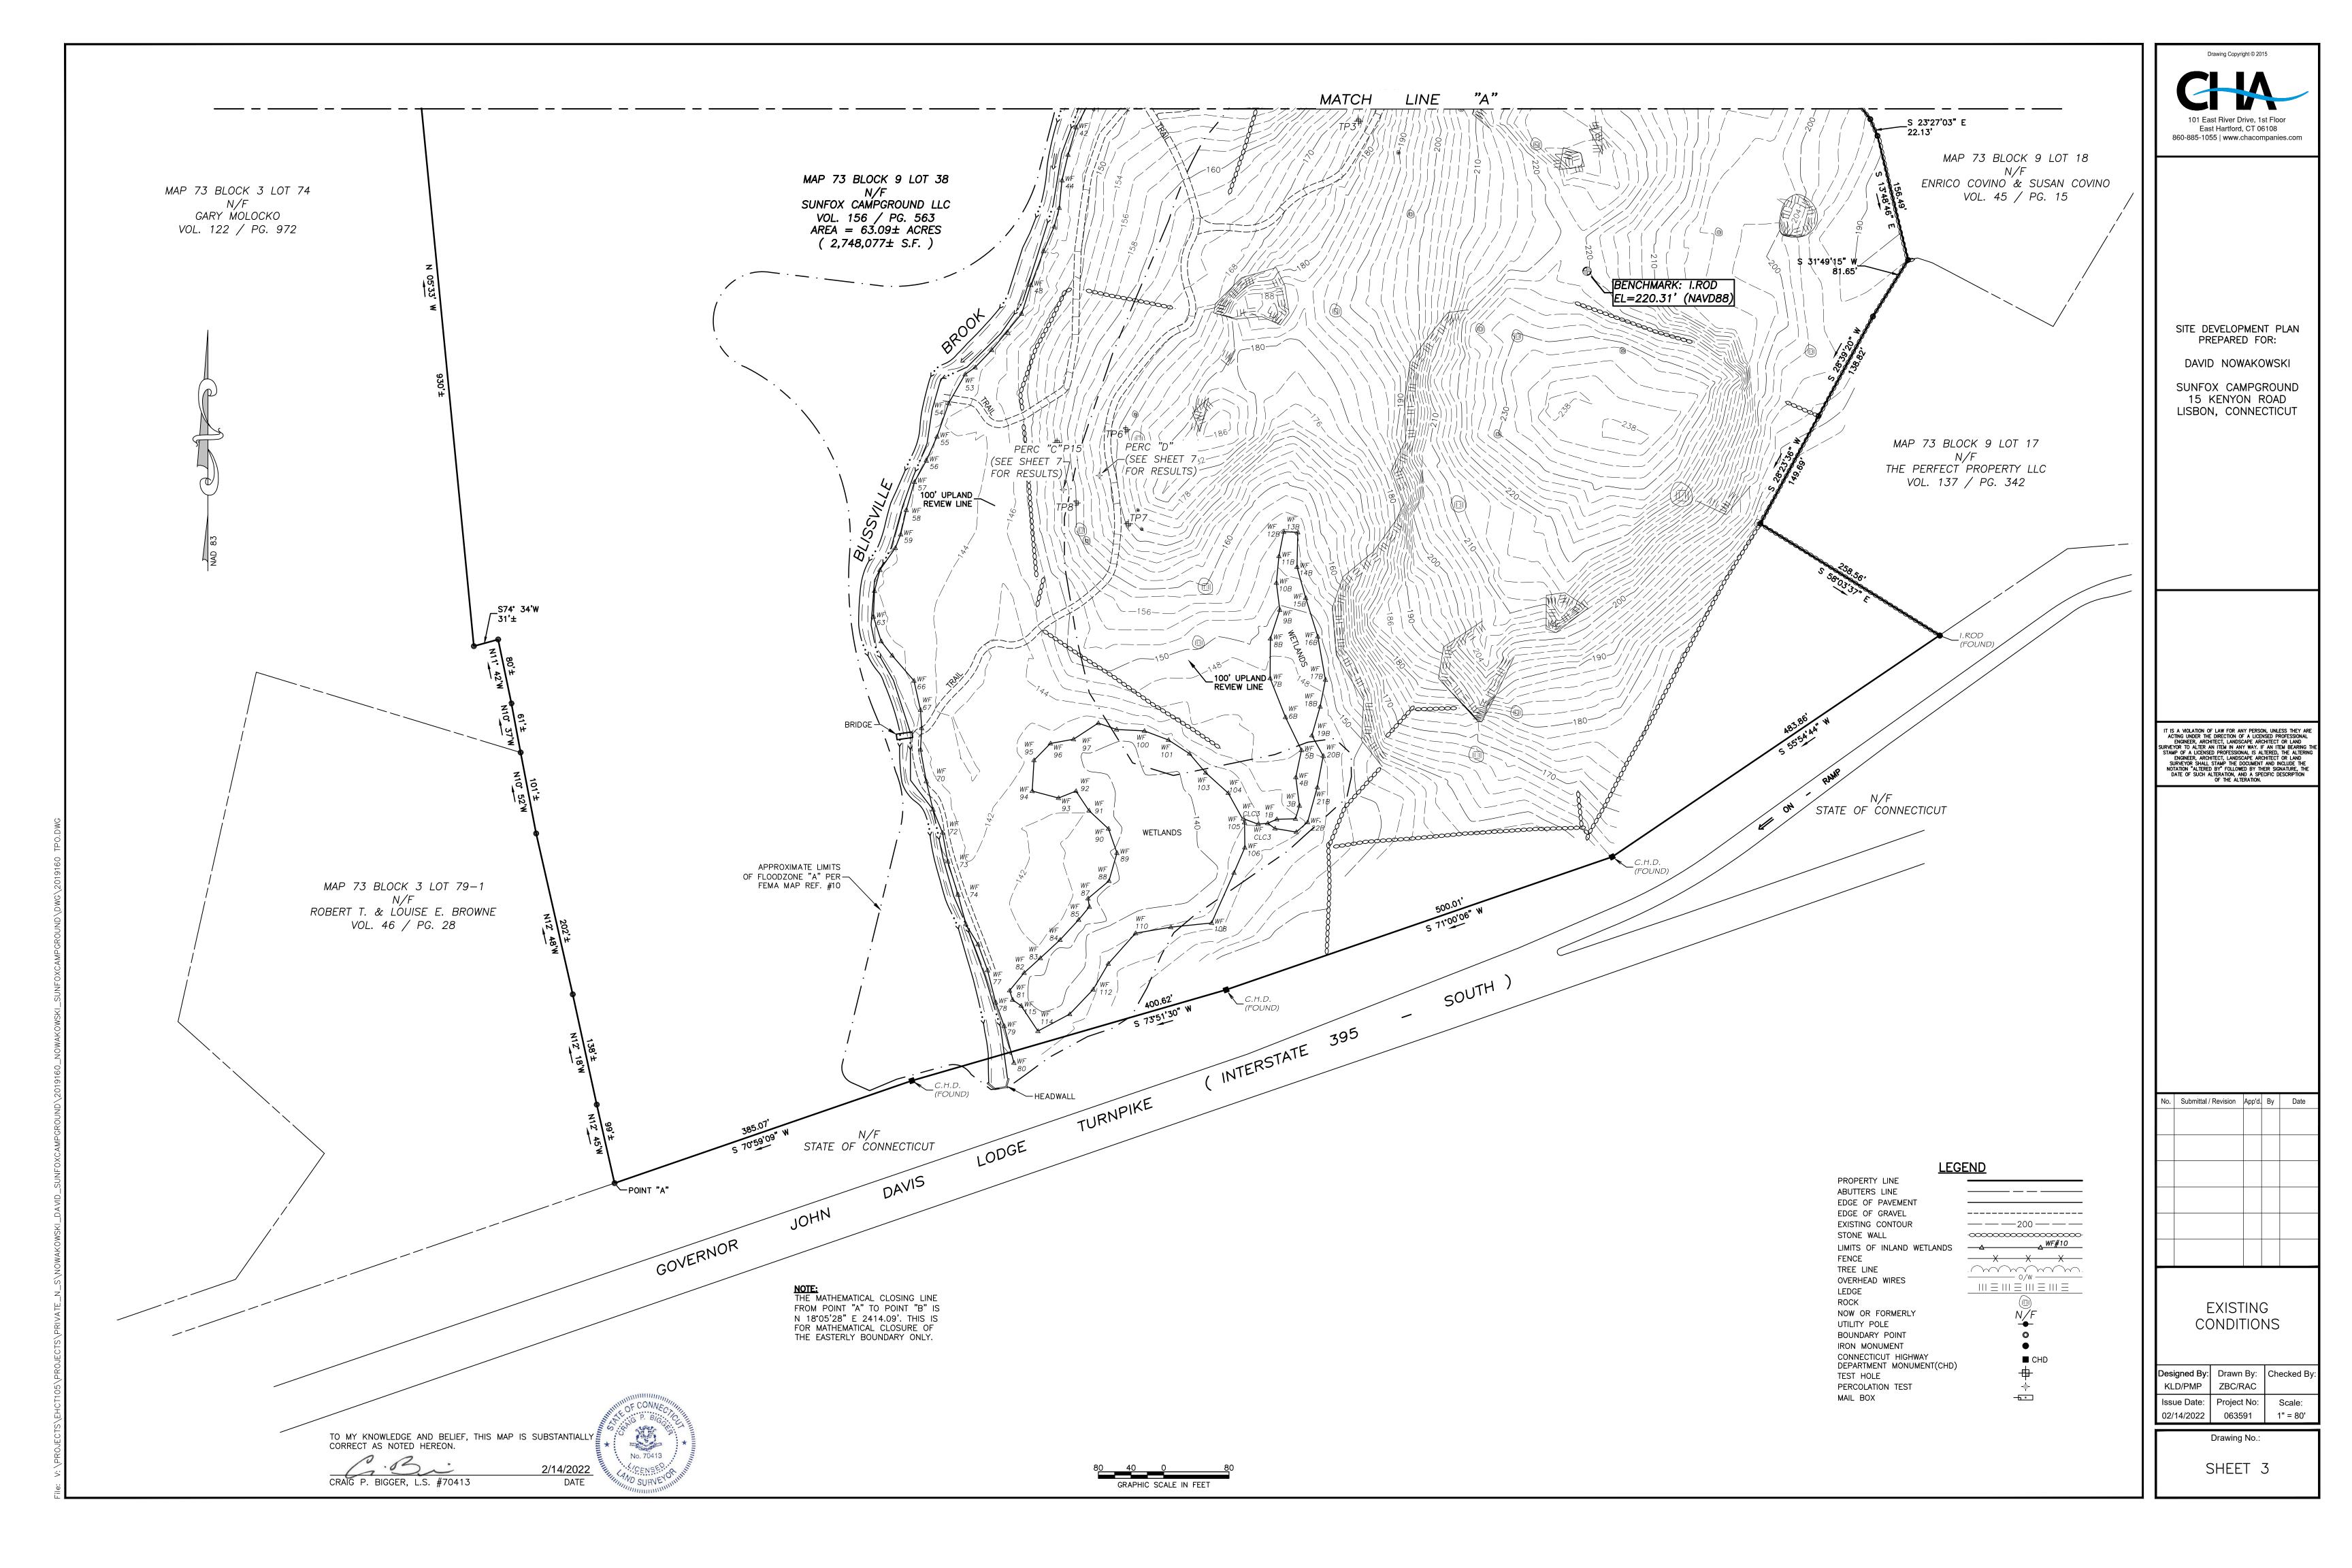

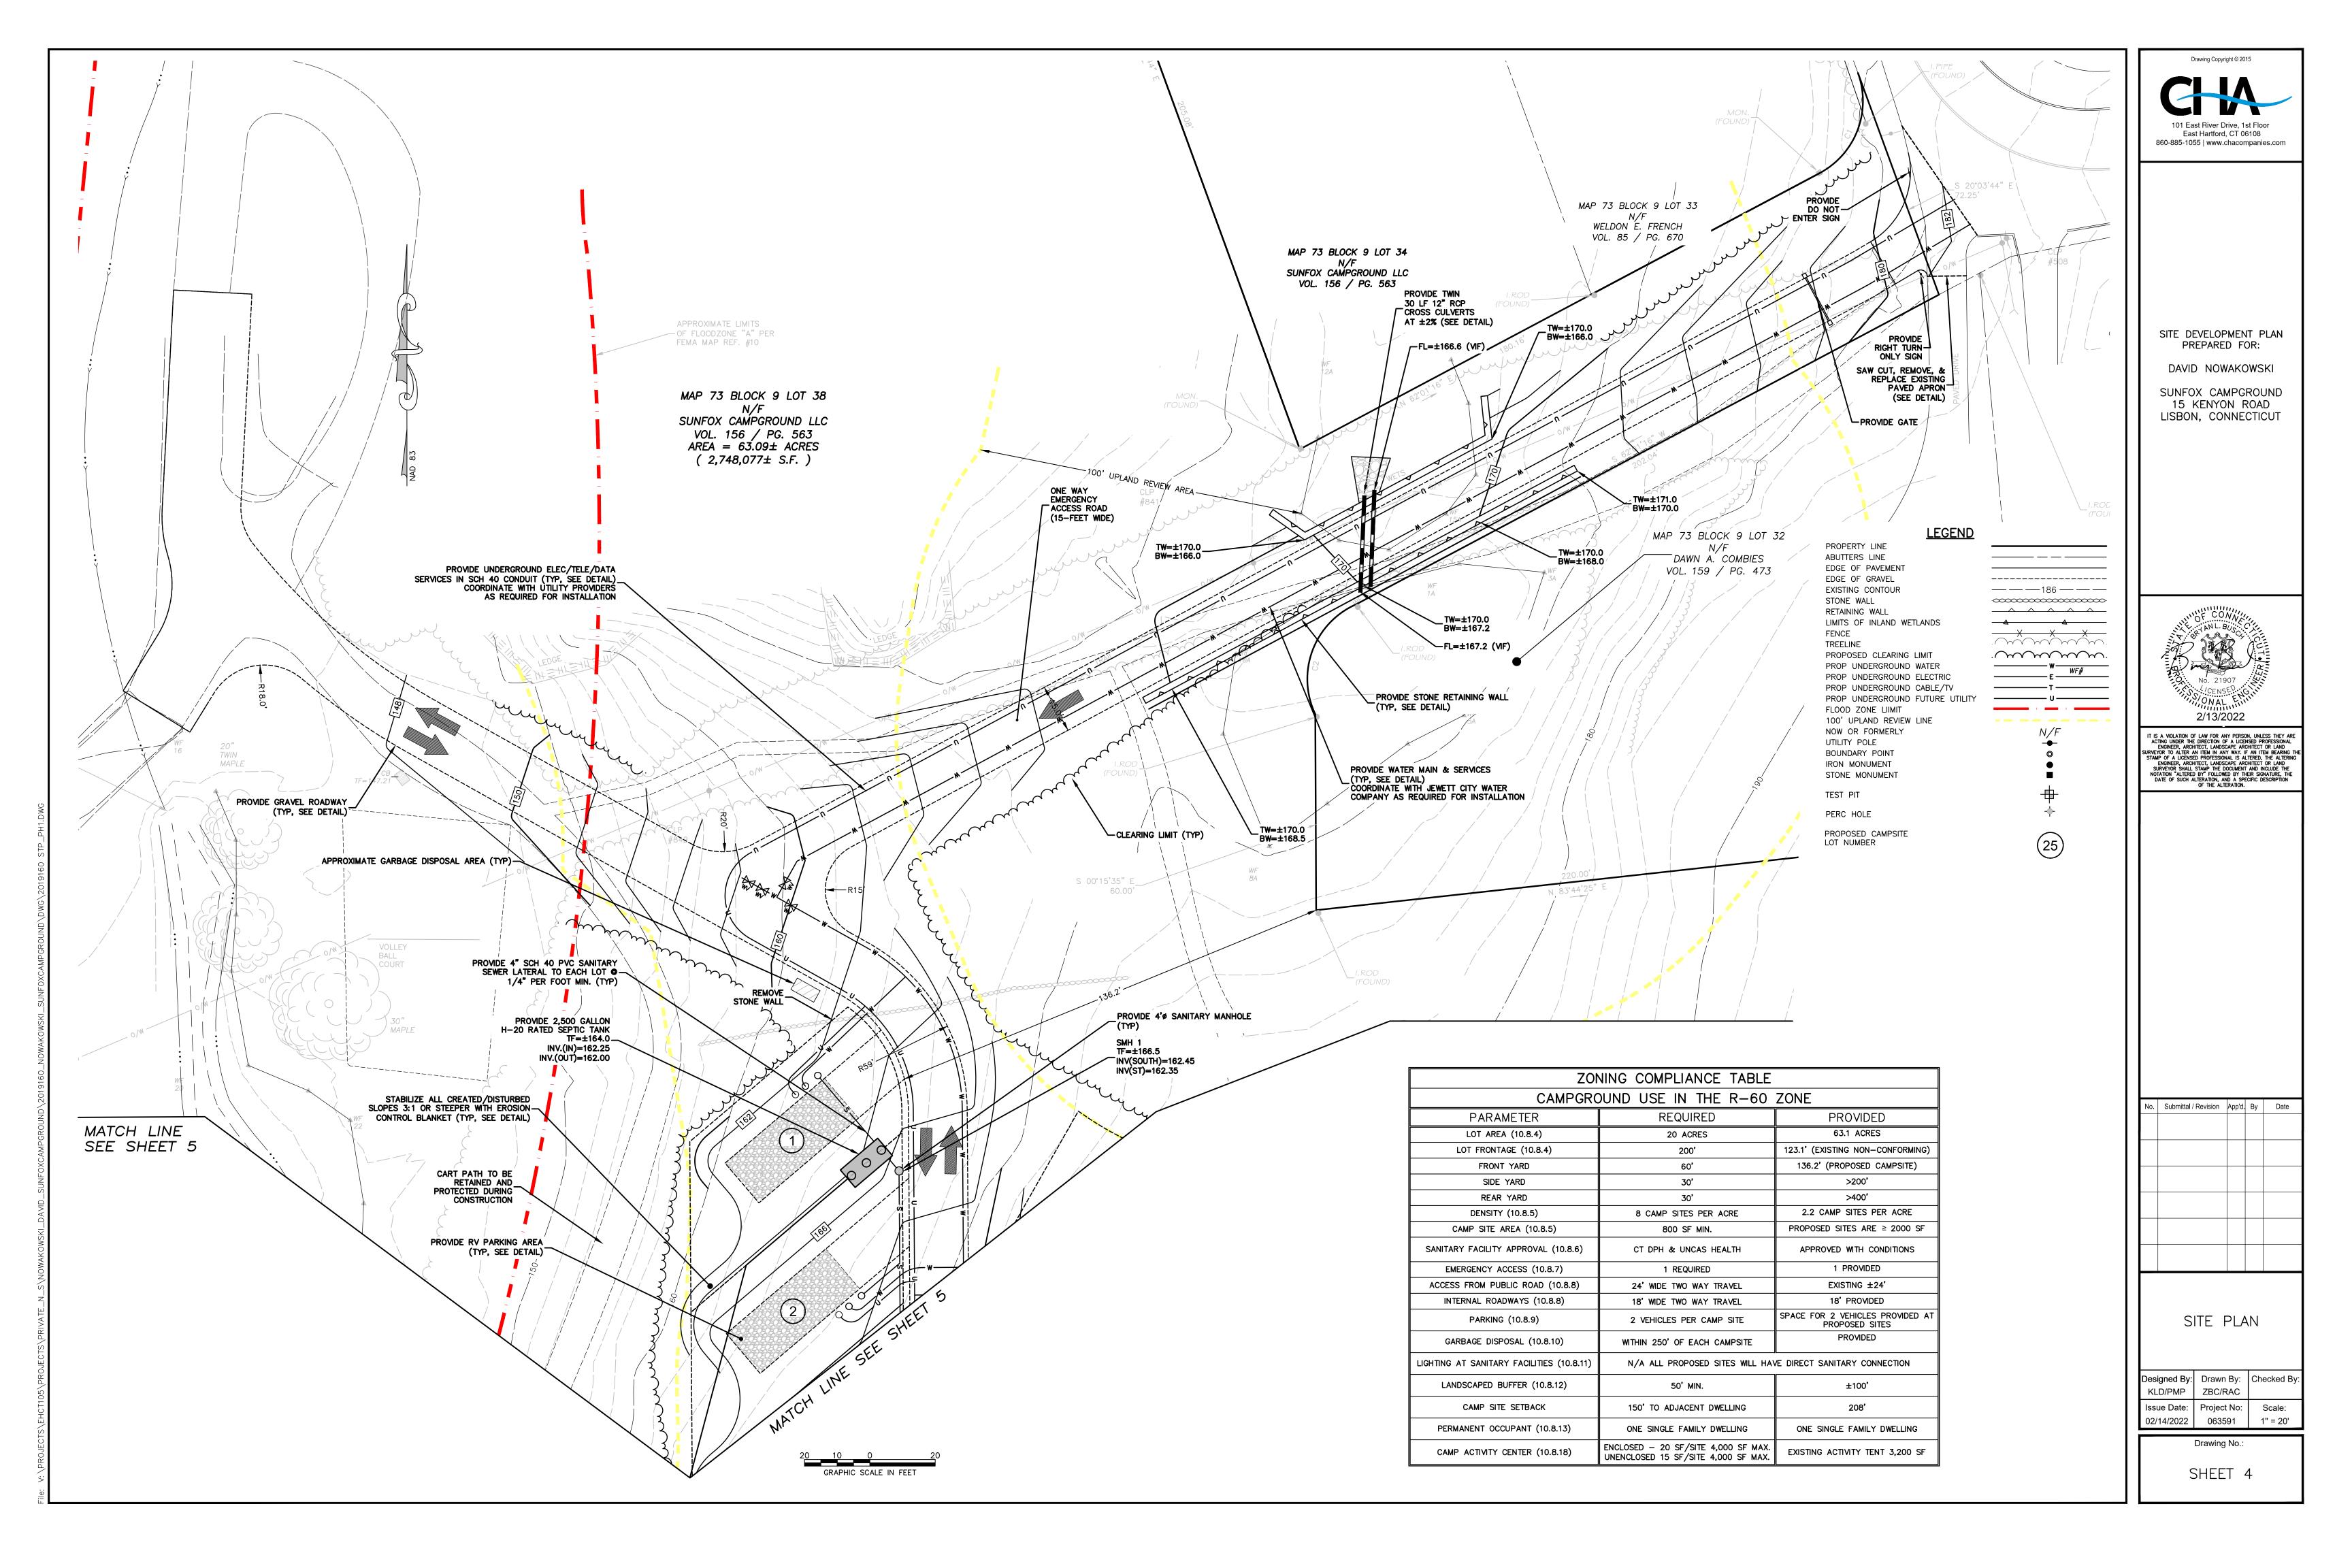


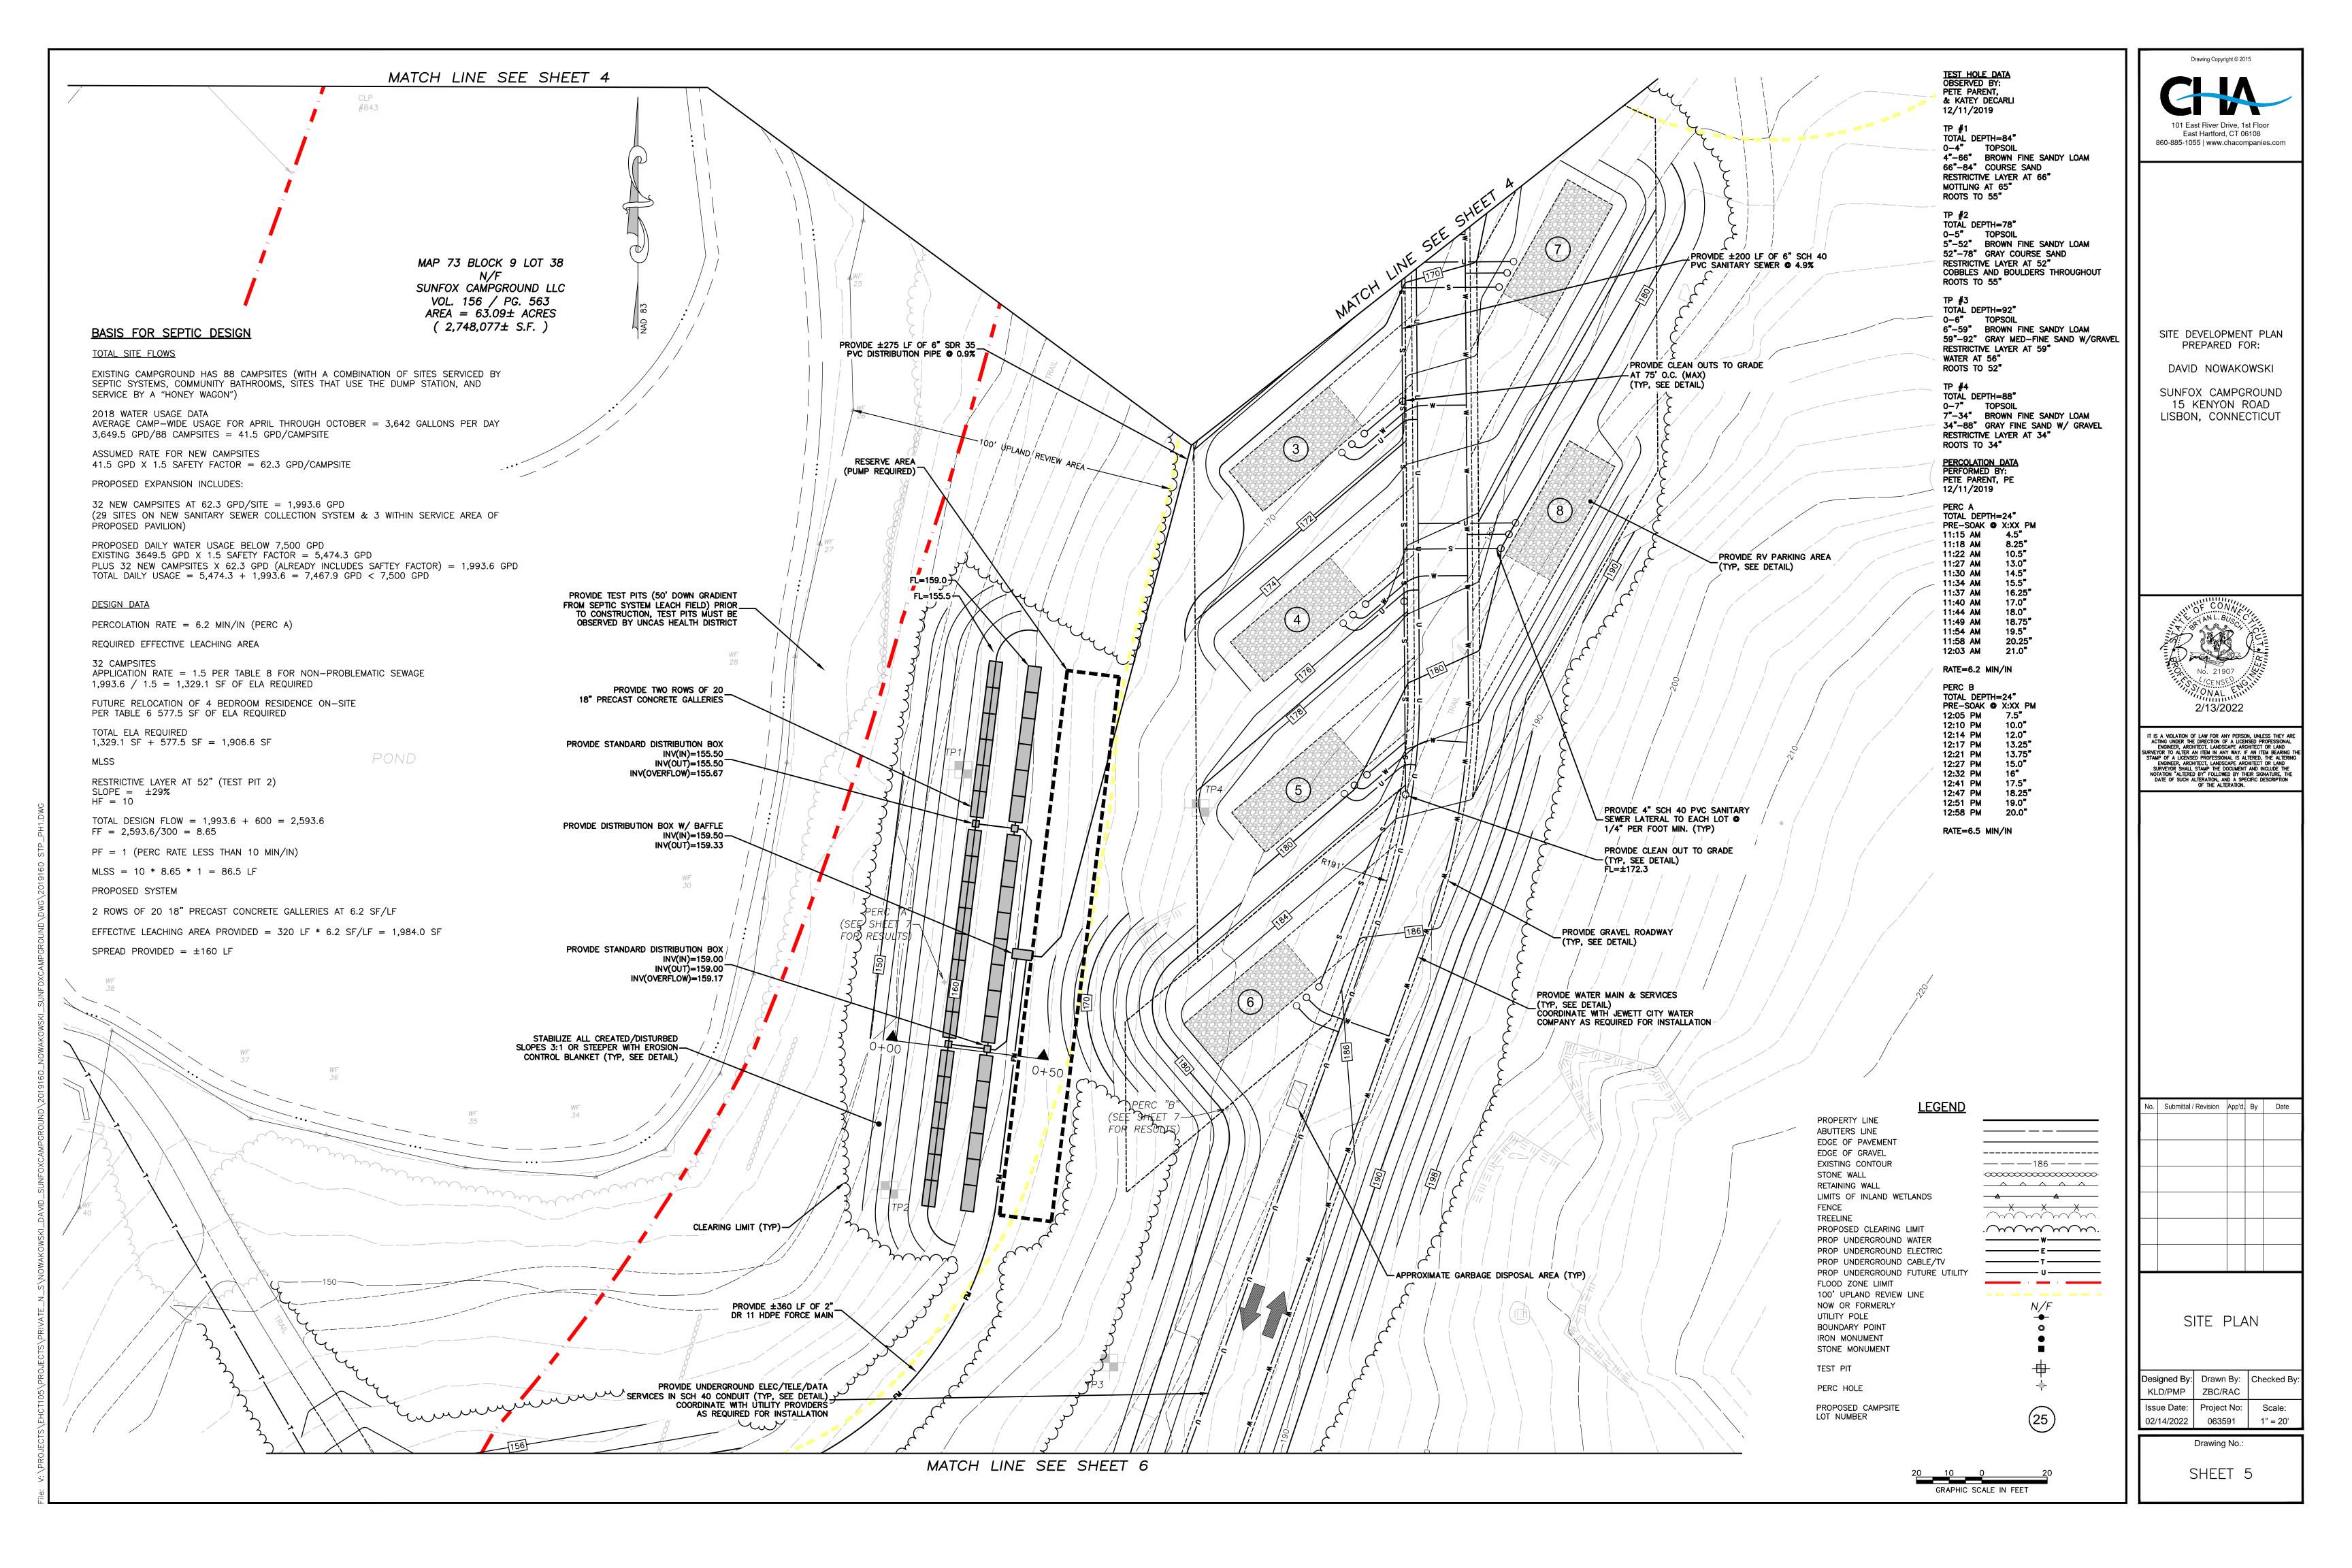


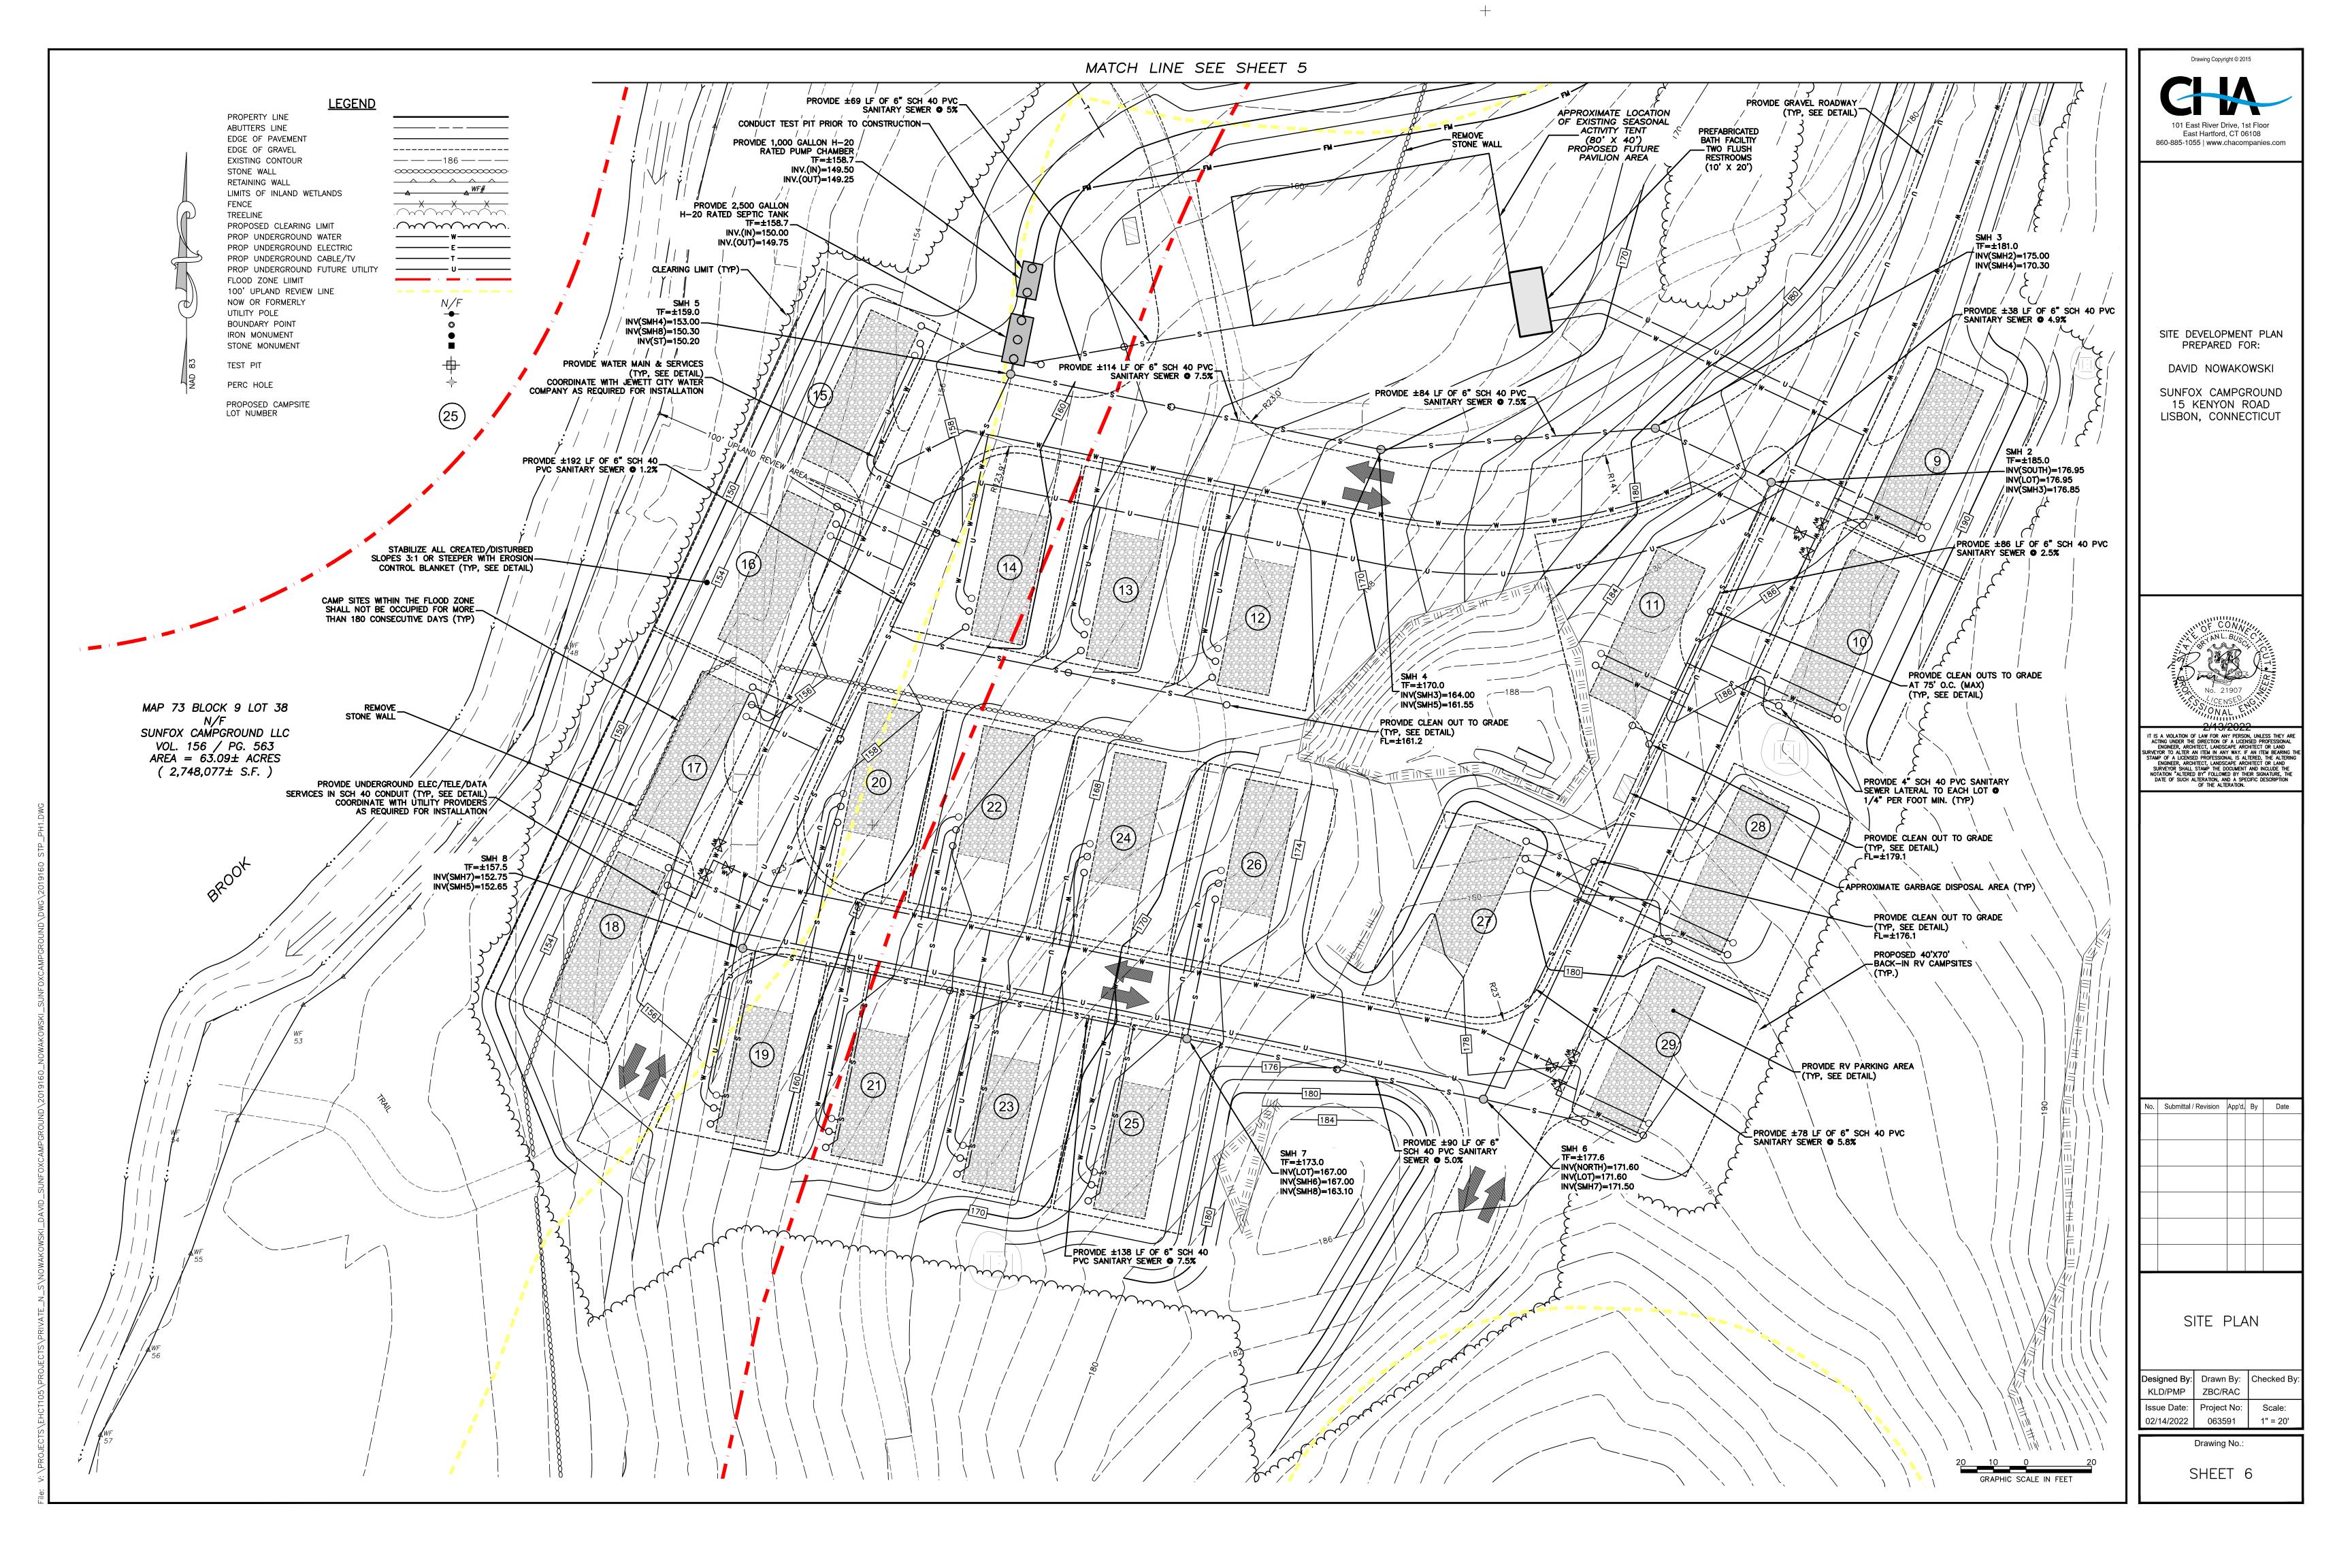

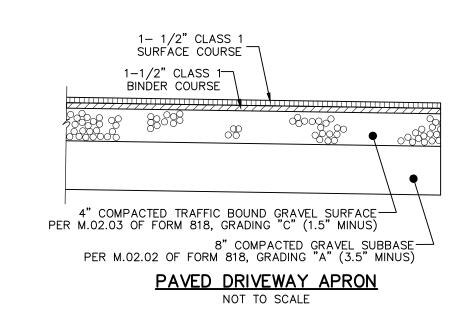

3" COMPACTED TRAFFIC BOUND GRAVEL SURFACE— PER M.02.03 OF FORM 818, GRADING "C" (1.5" MINUS)			
2" CT DOT #4 CRUSHED STONE (1.5" MINUS)————————————————————————————————————			
288 & 808 COOC 600			
8" COMPACTED GRAVEL SUBBASE——PER M.02.02 OF FORM 818, GRADING "A" (3.5" MINUS)			
GRAVEL ROADWAY NOT TO SCALE			

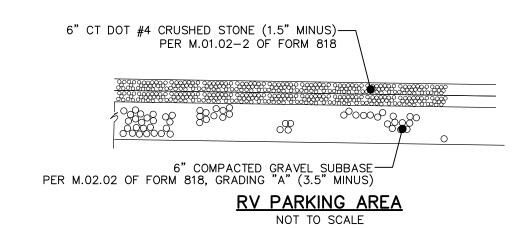

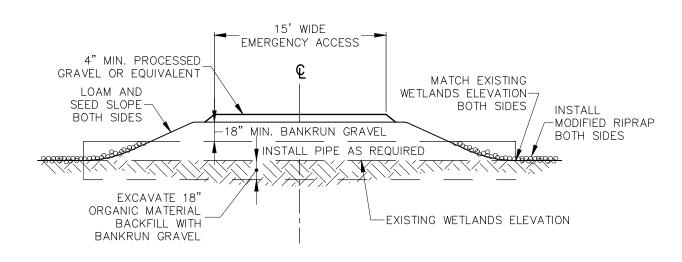

EMERGENCY ACCESS THROUGH INLAND WETLANDS


NOT TO SCALE

TRENCH PAY WIDTH SEE CHART					
		SUBGRA	ADE /		
PIPE	MAXIMUM	<i>'\?\/?\</i> 	COMPACTED	NA TIVE	
DIAMETER	TRENCH WIDTH		CÓMPAĆTEĎ Ń MÁTÉRIÁL BOŔRÓW	OR V	—SHEETING AS REQUIRED (TYPICAL)
≤6" 8"	2'-6" 3'-0"				
10" 12"	3'-0" 3'-0"				
15" 18"	3'-3" 3'-6"		WWW.		— COMPACTED SAND CUSHION *
21" 24"	4'-0" 4'-6"				FILTER FABRIC
30"	5'-0"		0.D.		3/4" CRUSHED STONE BEDDING MATERIAL *
		1/4 OD 6" MIN. 12" MINIMUM IN			— 12" FOUNDATION STONE WHEN * UNSUITABLE MATERIAL OR ORGANIC
		ROCK EXCAVATION			SILT IS ENCOUNTERED AT SUBGRADE
		TRENCH BOTTOM-			

TRENCH SECTION FOR SANITARY SEWER & STORM DRAINS NOT TO SCALE


NOTE:
BACKFILL MATERIAL TO BE PLACED IN 12" MAXIMUM LIFTS
& COMPACTED TO 95% MAXIMUM DRY DENSITY
(AS DETERMINED BY THE MODIFIED PROCTOR METHOD)

* PROVIDE NATIVE MATERIAL WITHIN 50' OF SEPTIC SYSTEM LEACHING FIELDS

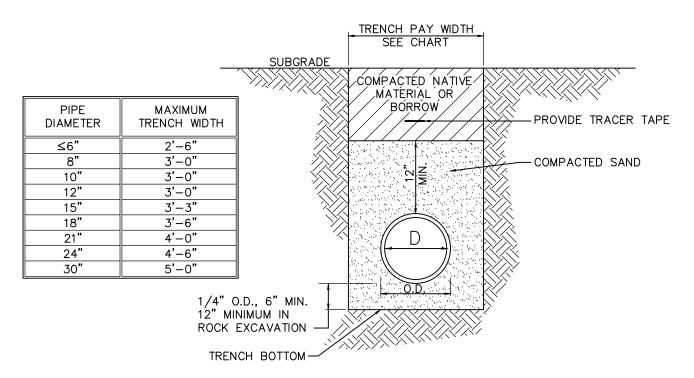


TRENCH SECTION FOR TYPICAL WATER TRENCH NOT TO SCALE

NOTE:
BACKFILL MATERIAL TO BE PLACED IN 12" MAXIMUM LIFTS
& COMPACTED TO 95% MAXIMUM DRY DENSITY
(AS DETERMINED BY THE MODIFIED PROCTOR METHOD)

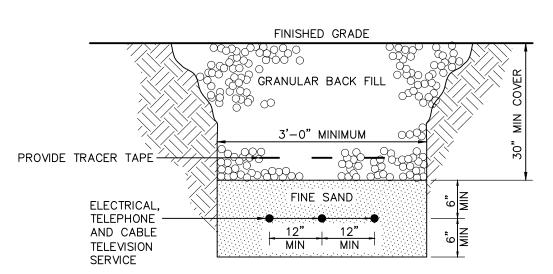

BURIED CABLE TRENCH
CROSS SECTION
NOT TO SCALE

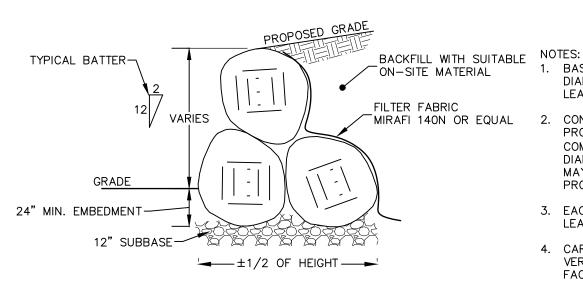

NOTES:

1. BASE ROCKS SHALL BE A MINIMUM OF 2' IN
DIAMETER AND HAVE AN APPROX. WEIGHT OF AT
LEAST 1,500 LBS.


FILTER FABRIC
MIRAFI 140N OR EQUAL

2. CONSECUTIVE TIERS OF ROCKS SHALL BECOME
PROGRESSIVELY SMALLER, WITH THE FINAL ROW BEING
COMPRISED OF ROCKS NO SMALLER THAN 12" IN
DIAMETER OR LESS THAN 150 LBS. SMALLER ROCKS
MAY BE USED TO FILL VOID SPACES BETWEEN
PROPERLY PLACED LARGER ROCKS.


3. EACH PROPERLY PLACED ROCK WILL BEAR ON AT LEAST TWO ADJACENT STONES.

 CARE MUST BE TAKEN TO AVOID CONTINUOUS VERTICAL OR HORIZONTAL JOINTS WITHIN THE STONE FACE.



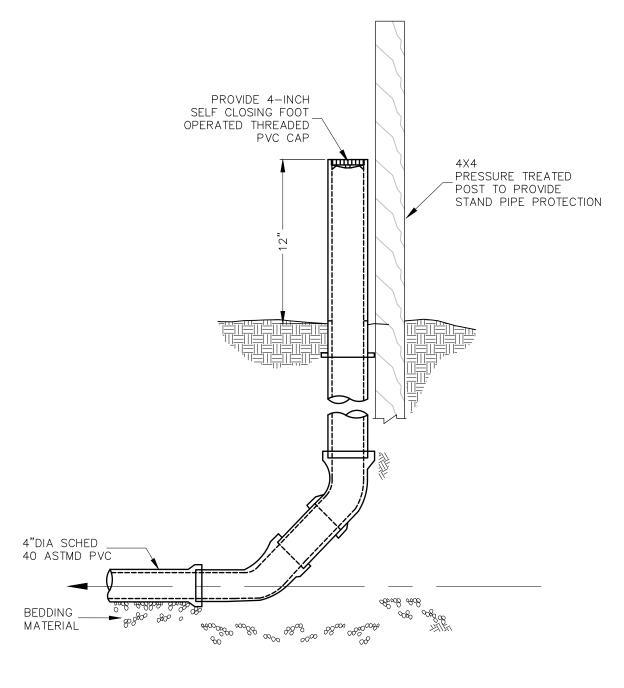

CAMP SITE SANITARY SERVICE STAND PIPE DETAIL

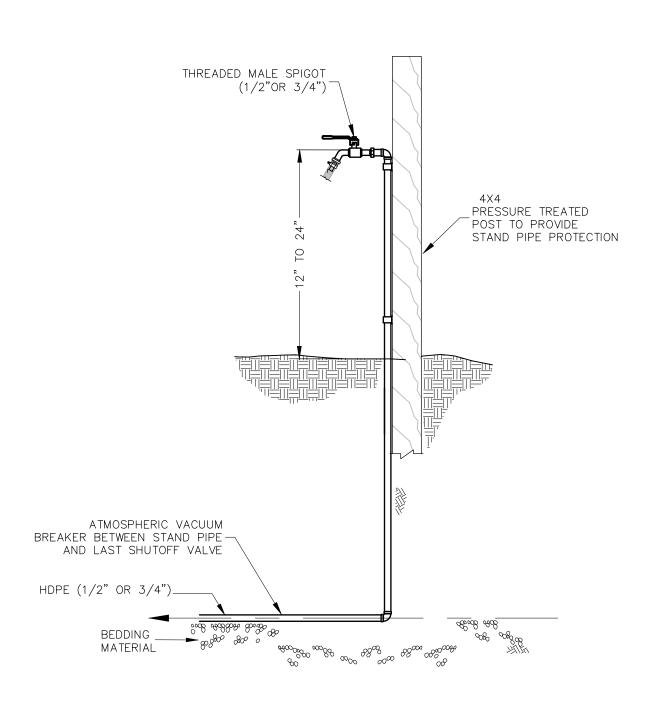

CAMP SITE WATER SERVICE STAND PIPE DETAIL

NOT TO SCALE

101 East River Drive, 1st Floor
East Hartford, CT 06108
860-885-1055 | www.chacompanies.com

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SITE DEVELOPMENT PLAN PREPARED FOR:

DAVID NOWAKOWSKI

SUNFOX CAMPGROUND 15 KENYON ROAD LISBON, CONNECTICUT



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No. Submittal / Revision App'd. By Date


CONSTRUCTION DETAILS

Designed By: Drawn By: Checked By KLD/PMP ZBC/RAC


Issue Date: Project No: Scale: 02/14/2022 063591 AS NOTED

Drawing No.:

SHEET 7

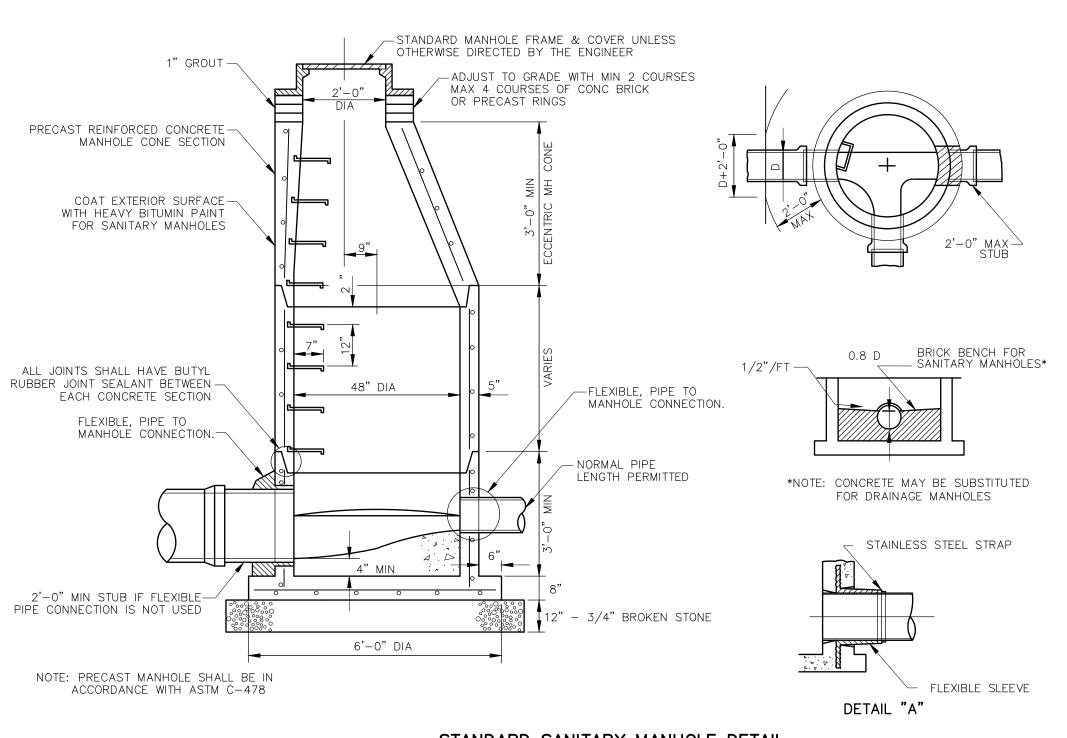

STANDARD SANITARY MANHOLE DETAIL

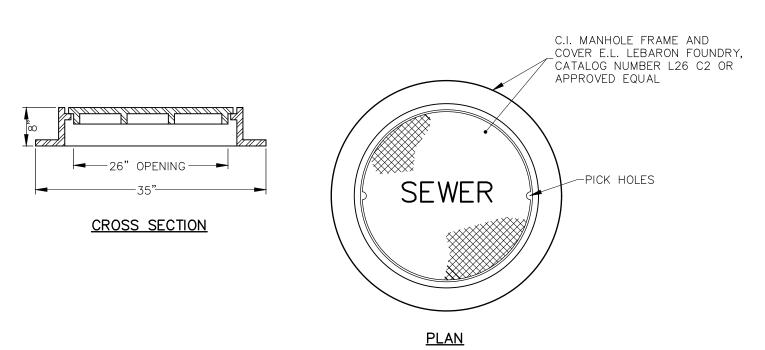

FRAME AND COVER NOT TO SCALE

SEPTIC SYSTEM FILL MATERIAL SPECIFICATIONS

1.) THE FILL SHALL NOT CONTAIN ANY MATERIAL LARGER THAN THREE(3) INCHES. 2.) UP TO 45% OF THE DRY WEIGHT OF THE REPRESENTATIVE SAMPLE MAY BE RETAINED ON THE #4 SIEVE (THIS IS THE GRAVEL PORTION OF THE SAMPLE). 3.) THE MATERIAL THAT PASSES THE #4 SIEVE IS THEN REWEIGHED AND THE SIEVE ANALYSIS STARTED 4.) THE REMAINING SAMPLE SHALL MEET THE FOLLOWING GRADATION CRITERIA.


WET SIEVE DRY SIEVE

70%-100% 70%-100% 10%-50% * 10%-75% 0%-20% 0%-5% 0%-5% 0%-2.5%


100%


PERCENT PASSING

*NOTE: PERCENT PASSING THE #40 SIEVE CAN BE INCREASED TO NO GREATER THAN 75% IF THE PERCENT PASSING THE #100 SIEVE DOES NOT EXCEED 10% AND THE #200 DOES NOT EXCEED 5%

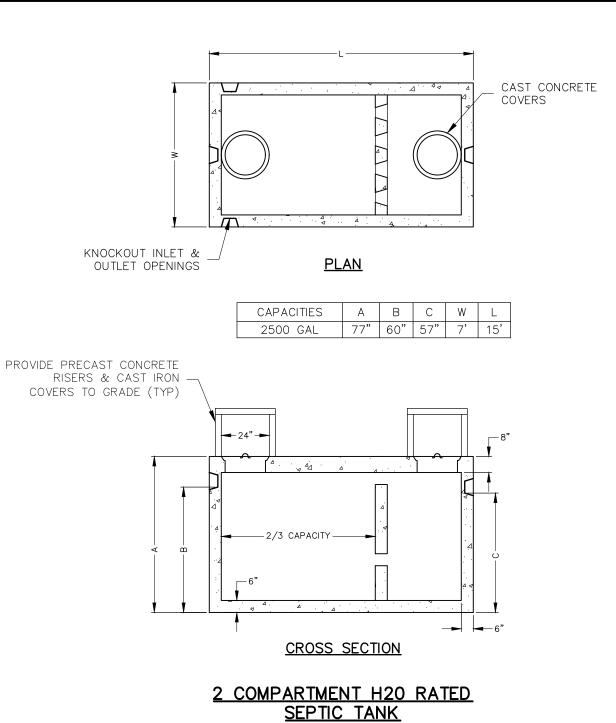

NOT TO SCALE NOTE: PROVIDE INLET BAFFLE & OUTLET FILTER AS REQUIRED BY HEALTH CODE

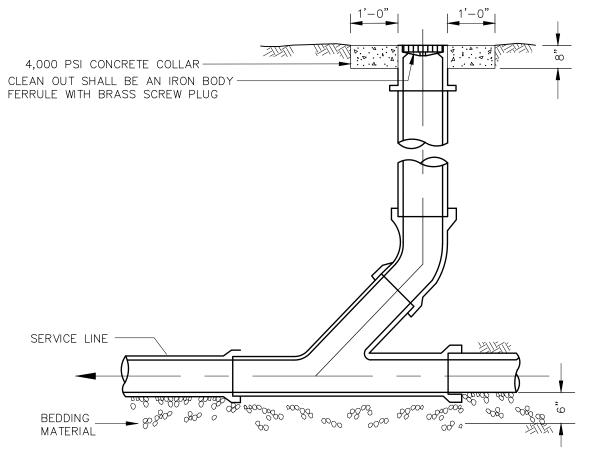

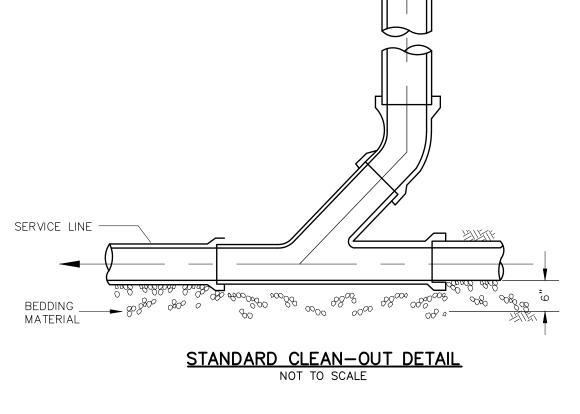

_KNOCKOUT INLET &
OUTLET OPENINGS

4'-6"

→ 6"

PROVIDE PRECAST CONCRETE

 $FL(IN) = 149.50 - \frac{1}{2}$

FL(OUT) = 149.25 ---

ALARM = 147.25 -

PUMP ON = 146.25 - -

PUMP OFF = 145.25 - -

BOTTOM = 144.75 --

LAG PUMP ON = 146.75 -

RISERS & CAST IRON-

COVERS TO GRADE (TYP)

PROVIDE ELECTRICAL

PROVIDE UNION-

CIRCUITRY AS REQUIRED

Δ Δ Δ Δ

BASIS OF DESIGN:

CAST CONCRETE

-PROVIDE WEEP HOLES

-PROVIDE CHECK VALVE

1000 GALLON H-20 RATED

PUMP CHAMBER

NOT TO SCALE

PROVIDE GALVANIZED RAIL SYSTEM

COVERS

164

PROPOSED

156

24" MIN.

152

0+00

SELECT FILL

0 + 50

SYSTEM PROFILE

SCALE:

HOR. 1"=30'

VERT. 1"=3"


RESTRICTIVE LAYER

DAILY DESIGN FLOW = $\pm 1,500$ GPD (24 SITES AT 62.3 GPD) PUMP CHAMBER: DOSE VOLUME = ± 250 GALLONS EMERGENCY STORAGE = ± 500 GALLONS


PUMP CHAMBER:

JOLLEY PRECAST 1,000 GALLON H20 LOADING SINGLE COMPARTMENT SEPTIC TANK CAPACITY PER FOOT OF DEPTH = $4.625 \times 7.5 \times 7.48 = 259.5$ GAL./FT. INSIDE DIMENSIONS OF CHAMBER = 4.625' WIDE X 7.5' LONG X 4.5' HIGH X 7.48 = 1,167.6 GALLONS


DUPLEX PUMPS SHALL BE MYERS CONTINUOUS DUTY STAINLESS STEEL PUMP MODEL DE40PC1 2" DISCHARGE ALTERNATING SYSTEM OR EQUAL AS APPROVED BY THE ENGINEER. DISCHARGE LINE SHALL BE INSTALLED WITH 4' OF COVER TO PREVENT FREEZING. ALARM SHALL BE LOCATED IN THE PAVILION BUILDING AND BE POWERED BY A CIRCUIT SEPARATE FROM THE CIRCUIT OF THE PUMP. THE ALARM SHALL BE LOCATED IN AN AREA WHERE IT WILL BE EASILY AUDIBLE. ELECTRICAL CONNECTIONS SHALL BE MADE IN CODE COMPLIANT ACCESS BOXES OUTSIDE OF THE PUMP CHAMBER. PUMP DISCHARGE LINE SHALL BE FITTED WITH UNION TO ALLOW EASY REMOVAL OF THE PUMPS WHEN TANK IS FULL.

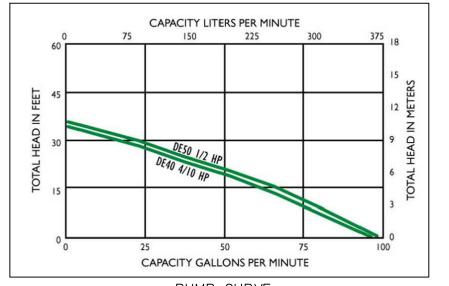

PUMP CURVE

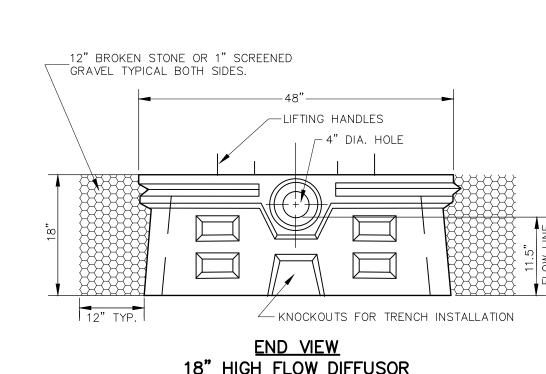

18" HIGH FLOW DIFFUSOR NOT TO SCALE

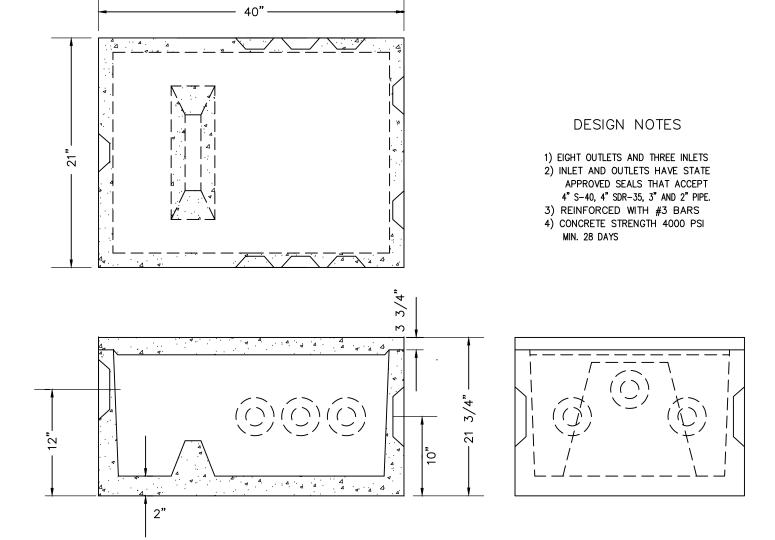

DISTRIBUTION BOX /W BAFFLE

2X2 5/8 16 GA.

WIRE MESH

STANDARD D-BOX

CONSTRUCTION SCHEDULE

.) REMOVE AND STOCKPILE TOPSOIL. .) PLACE SELECT FILL ACCORDING TO CT. STATE HEALTH CODE REQUIREMENTS. 3.) EXCAVATE 4' WIDE TRENCHES AND PREPARE SURFACE.
4.) FILL TRENCHES WITH APPROVED AGGREGATE TO HEIGHT OF PIPE INVERTS PLACE PIPE IN TRENCH, AND FILL TO 2" OVER TOP OF PIPE.
5.) CAP ENDS OF PIPES. .) PLACE A 4' WIDE STRIP OF NON-WOVEN FILTER FABRIC ON TOP OF THE ENTIRE LENGTH OF THE SYSTEM, AND BACKFILL WITH NATIVE MATERIAL.

7.) REPLACE TOPSOIL, SEED & MULCH.

CONSTRUCTION NOTES

1.) BOTTOM OF ALL TRENCHES AND LEACHING PIPE SHALL BE LEVEL THROUGHOUT UNDER NO CIRCUMSTANCES SHALL ANY PIPE IN A TRENCH HAVE A PITCH EXCEEDING 1" 2.) PIPE BETWEEN THE HOUSE AND THE SEPTIC TANK SHALL BE SCHED. 40 ASTM D 1785 PVC:THIS PIPE SHALL HAVE A MINIMUM SLOPE OF 0.25" PER 1'.

3.) ALL DISTRIBUTION PIPES TO BE 4" PVC OR POLYETHYLENE PIPE AS SPECIFIED IN SEC. 19–13–B103, TABLE 5 OF THE CT. STATE HEALTH CODE.

4.) ALL CONSTRUCTION SHALL BE IN CONFORMANCE WITH CT. STATE HEALTH CODE.


5.) ALL TOPSOIL IN THE LOCATION OF THE PROPOSED SYSTEM SHALL BE REMOVED AND STOCKPULED PRIOR TO EXCAVATION. AND STOCKPILED PRIOR TO EXCAVATION. 6.) FILL MATERIAL FOR SEPTIC AREA IS TO BE SELECT FILL PER CT. STATE HEALTH CODE 7.) SEPTIC TANKS AND DISTRIBUTION BOXES SHALL BE PLACED ON 6" COMPACTED 8.) RESERVE LEACHING AREA TO BE OF EQUAL SIZE TO PRIMARY LEACHING AREA.

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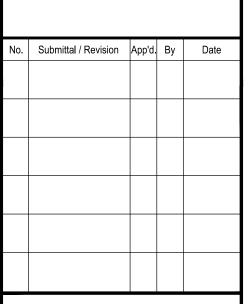
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DAVID NOWAKOWSKI

SUNFOX CAMPGROUND 15 KENYON ROAD LISBON, CONNECTICUT



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CONSTRUCTION DETAILS

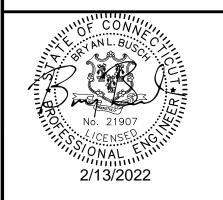Designed By: Drawn By: Checked By KLD/PMP ZBC/RAC Issue Date: Project No: Scale:


063591

02/14/2022

Drawing No.:

AS NOTE

SHEET 8

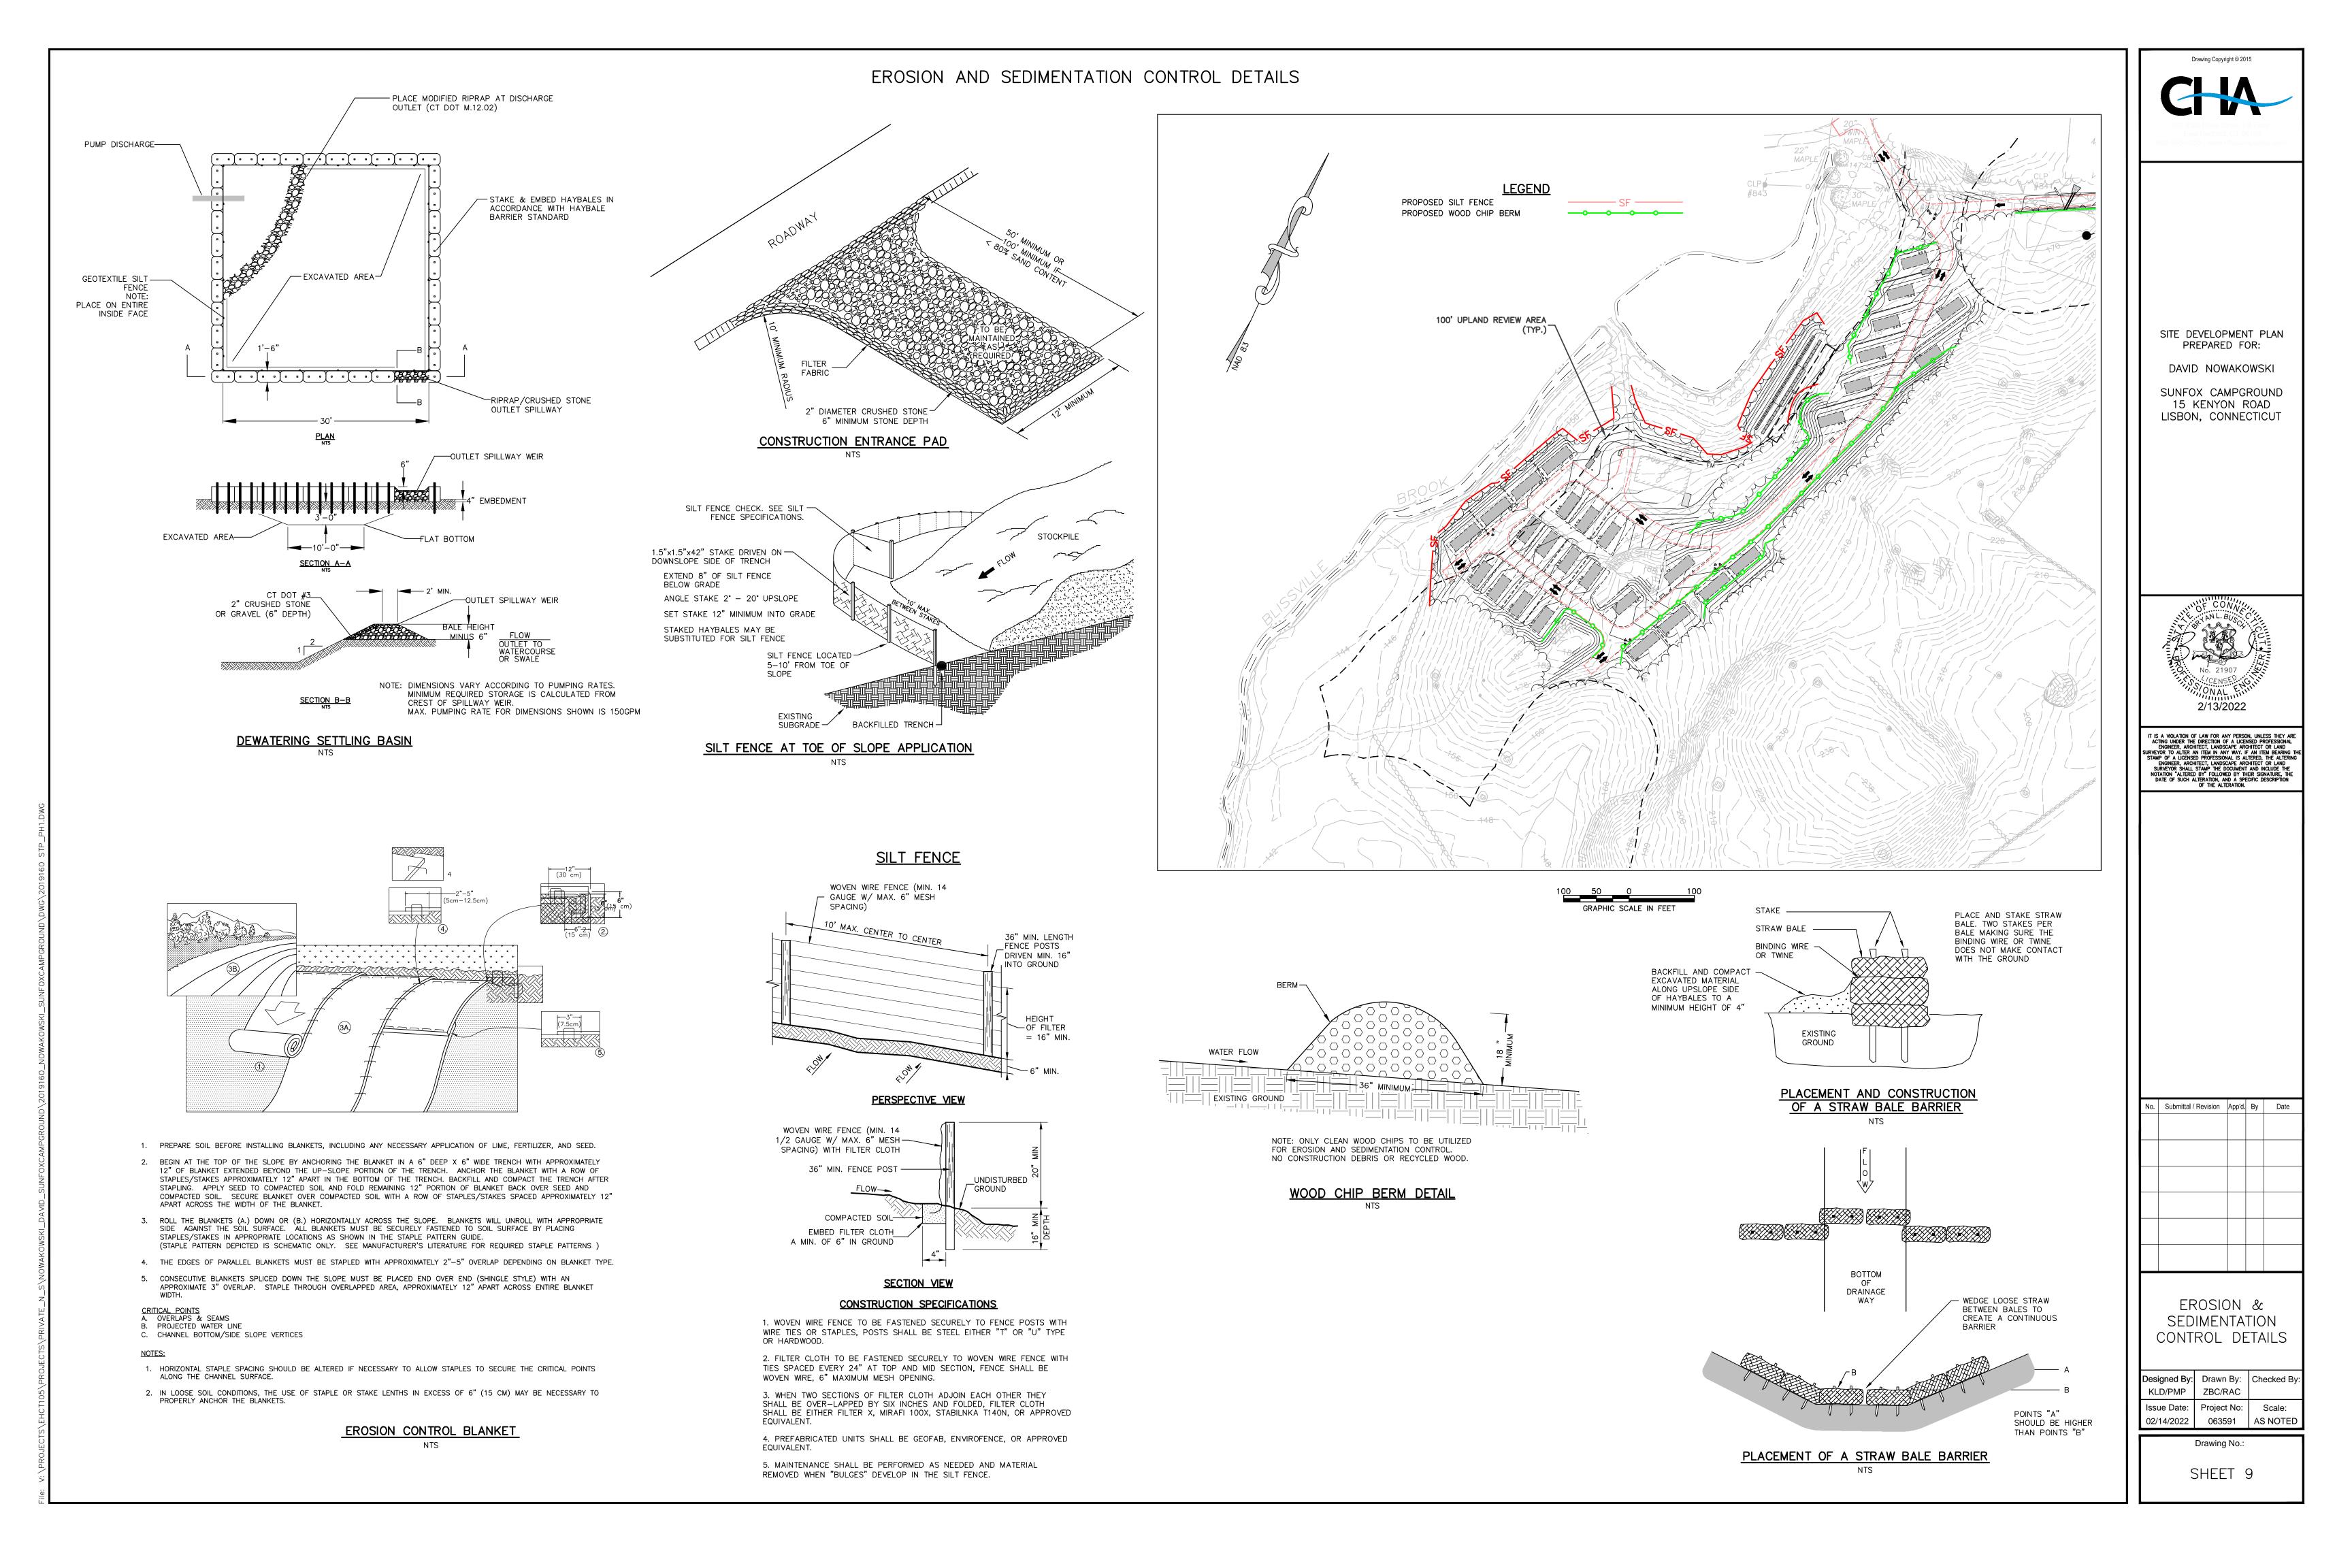

THIS PROJECT REQUIRES THE FOLLOWING PERMITS: UNCAS HEALTH DISTRICT SSDS

THIS PROJECT REQUIRES THE APPROVAL OF THE FOLLOWING BOARDS/COMMISSIONS:

TOWN OF LISBON CONSERVATION COMMISSION (APPLICATION #21-005 APPROVED ON 8/17/2021)

TOWN OF LISBON PLANNING AND ZONING COMMISSION

ESTIMATED CONSTRUCTION SCHEDULE

- A. INSTALL EROSION AND SEDIMENT CONTROL SYSTEMS OCTOBER 2022
- B. ROUGH GRADE SITE OCTOBER DECEMBER 2022
- C. INSTALL UTILITIES AND SEPTIC SYSTEMS MARCH JUNE 2022
- D. CONSTRUCT ROADWAY JULY 2023
- F. FINISH GRADE SITE AUGUST OCTOBER 2023

PROJECT SEQUENCE

- A. STAKEOUT LIMIT OF DISTURBANCE.
- B. HOLD PRECONSTRUCTION MEETING.
- C. CONTACT "CALL BEFORE YOU DIG" AT 1-800-922-4455 (CT) OR CONTACT "DIG SAFE" AT 1-888-344-7233. (MA) TWO (2) WORKING DAYS PRIOR TO THE START OF ANY CONSTRUCTION ACTIVITY.
- D. INSTALL CONSTRUCTION ENTRANCE.
- E. INSTALL TOE OF SLOPE PERIMETER FILTER (SILT FENCE OR HAYBALES) DOWN GRADIENT FROM ALL AREAS OF LAND CLEARING AND CONSTRUCTION ACTIVITY.
- F. PERFORM ALL NECESSARY CLEARING AND GRUBBING OPERATIONS.
- G. EXCAVATE ALL STUMPS LOCATED AND REMOVE TO A STOCKPILE AREA TO BE
- H. STRIP AND STOCKPILE TOPSOIL IN AN APPROVED AREA AND SECURE WITH EROSION AND SEDIMENT CONTROLS.
- I. ROUGH GRADE PROPOSED ROADWAY.
- J. CONSTRUCT SEPTIC SYSTEM.
- K. GRADE CAMP SITES.
- L. INSTALL UTILITIES
- M. INSTALL AND GRADE ROADWAY SUBBASE.
- N. INSTALL PROCESSED AGGREGATE IN CAMP SITES
- O. FINISH GRADE ROADWAY.
- P. COMPLETE THE BALANCE OF SITE WORK AND STABILIZATION OF ALL OTHER DISTURBED AREAS.
- P. REMOVE TEMPORARY EROSION AND SEDIMENT CONTROLS.

NOTES:

- SEVERAL OF THE ABOVE ACTIVITIES MAY BE DONE SIMULTANEOUSLY.
- THE DEVELOPMENT IS EXPECTED TO PROCEED WITH STABILIZATION OCCURRING AS GRADING PROCEEDS. DISTURBANCE IS NOT EXPECTED TO EXCEED ONE(1) ACRE AT ANY ONE TIME. A SEDIMENT TRAP, PER CT SEDIMENT AND EROSION CONTROL MANUAL, MUST BE INSTALLED IF MORE THAN ONE(1) DISTURBED ACRES WILL DISCHARGE TO ONE AREA.

SEEDING SPECIFICATIONS

- A. IF GROUND HAS BEEN PREVIOUSLY MULCHED, MULCH MUST BE REMOVED OR ADDITIONAL NITROGEN MUST BE ADDED.
- B. REMOVE ALL SURFACE STONES 2" OR LARGER AS WELL AS ALL DEBRIS SUCH AS WIRE, CABLE, TREE ROOTS, PIECES OF CONCRETE, CLODS, CLUMPS, OR OTHER UNSUITABLE MATERIAL.
- C. APPLY FERTILIZER AT 7.5 POUNDS PER 1,000 SQUARE FEET AND LIME AT 200 POUNDS PER 1,000 SQUARE FEET UNLESS SOIL TESTING FOR REQUIREMENTS IS PERFORMED.
- D. NO MOWING IS TO BE UNDERTAKEN UNTIL THE MAJORITY OF THE VEGETATION IS AT LEAST 6" HIGH. MOWING SHOULD CUT THE TOP 1/3 OF VEGETATION. DO NOT UNDER ANY CIRCUMSTANCES CUT VEGETATION BELOW 3".
- E. DO NOT APPLY ANY FORM OF WEED CONTROL UNTIL GRASS HAS BEEN MOWED AT LEAST 4 TIMES.
- F. THESE SEEDING MEASURES ARE NOT TO BE USED ON SLOPES IN EXCESS OF 2:1 GRADING.
- G. PERMANENT SEEDING MEASURES ARE TO BE USED INSTEAD OF TEMPORARY SEEDING MEASURES WHERE WORK IS TO BE SUSPENDED FOR A PERIOD OF TIME LONGER THAN 1 YEAR.
- H. IF THERE IS NO EROSION, BUT SEED SURVIVAL IS LESS THAN 100 PLANTS PER SQUARE FOOT AFTER 4 WEEKS OF GROWTH, RE—SEED AS PLANTING SEASON ALLOWS.
- I. ALL DISTURBED AREAS OUTSIDE THE PAVEMENT AREA, WITHIN AND OUTSIDE THE ROAD RIGHT OF WAY, SHALL BE RESTORED IN ACCORDANCE WITH THE CITY/TOWN SUBDIVISION REGULATIONS.

EROSION & SEDIMENT CONTROL OPERATIONS AND MAINTENANCE

- A. EROSION AND SEDIMENTATION CONTROL AND RESTORATION MEASURES SHALL CONFORM TO THE "2002 CONNECTICUT GUIDELINES FOR SOIL EROSION AND SEDIMENTATION CONTROL", PUBLISHED BY THE CONNECTICUT COUNCIL OF SOIL AND WATER CONSERVATION AND THE CONNECTICUT DEPARTMENT OF ENVIRONMENTAL PROTECTION AND TO TOWN REGULATIONS.
- B. INSTALLATION OF SEDIMENT AND EROSION CONTROLS SUCH AS HAYBALES AND SILT FENCES SHALL BE ESTABLISHED PRIOR TO COMMENCING ANY LAND DISTURBANCE ACTIVITIES.
- C. ALL STOCKPILED MATERIAL SHALL BE RINGED WITH HAYBALES OR SILT FENCES. ANY MATERIAL TO BE STOCKPILED LONGER THAN 14 DAYS SHALL BE STABILIZED WITH TEMPORARY SEEDING OR JUTE NETTING.
- D. HAYBALE FILTERS OR SILT FENCE SHALL BE PLACED 5-10 FEET FROM THE TOE OF ALL CRITICAL SLOPES AS SHOWN ON THE PLAN. THESE SHALL BE CHECKED BY THE CONTRACTOR REGULARLY AND REPAIRED WHENEVER THEY FAIL TO INSURE CLEAN RUN-OFF FROM THE SITE.
- E. ADDITIONAL CONTROL MEASURES IF REQUESTED BY THE TOWN SHALL BE INSTALLED IMMEDIATELY UPON REQUEST.
- F. ALL DISTURBED AREAS SHALL BE PROTECTED WITH A MINIMUM VEGETATION COVER AS SHOWN IN ACCOMPANYING CHART.
- G. THE CONTRACTOR SHALL PLAN ALL LAND DISTURBING ACTIVITIES IN A MANNER AS TO MINIMIZE THE EXTENT OF THE DISTURBED AREAS.
- H. THE CONTRACTOR SHALL MAKE DAILY INSPECTIONS OF THE SITE TO INSURE EFFECTIVENESS OF EROSION AND SEDIMENTATION CONTROL MEASURES AND WILL IMMEDIATELY MAKE NECESSARY REPAIRS IF REQUIRED BY THE CITY/TOWN.
- I. ALL EROSION AND SEDIMENT CONTROL MEASURES ARE TO BE INSPECTED AT A MINIMUM OF ONCE A WEEK AND WITHIN 24 HOURS OF THE END OF A STORM WITH A RAINFALL AMOUNT OF 0.1 INCHES OR GREATER TO DETERMINE MAINTENANCE NEEDS.
- J. ALL EROSION AND SEDIMENT CONTROL MEASURES ARE TO BE REPLACED WITHIN 24 HOURS OF AN OBSERVED FAILURE.
- K. ALL CONSTRUCTION TRAFFIC SHALL ENTER AND LEAVE BY THE DESIGNATED ENTRANCE. THIS ENTRANCE SHALL BE CONSTRUCTED OF CRUSHED STONE TO HELP FREE TIRES OF SOIL WHEN LEAVING THE SITE. THE CONTRACTOR SHALL INSTRUCT ALL VEHICLE DRIVERS TO CLEAN SOIL MATERIAL FROM TIRES IN FRONT OF THE SITE. ALL SOIL, MISCELLANEOUS DEBRIS, OR OTHER MATERIAL SPILLED, DUMPED OR OTHERWISE DEPOSITED ON PUBLIC STREETS, HIGHWAYS, SIDEWALKS OR OTHER PUBLIC THOROUGHFARES DURING TRANSIT TO OR FROM THE SITE SHALL BE REMOVED PROMPTLY.
- O. THE CONTRACTOR HEREBY ACKNOWLEDGES HIS RESPONSIBILITY TO INSTALL SOIL EROSION AND SEDIMENTATION CONTROL MEASURES ON THIS SITE AND THAT HIS FAILURE TO INSTALL AND MAINTAIN THESE DEVICES COULD RESULT IN FINES OR SUSPENSION OF WORK BY THE CITY/TOWN.
- P. MINIMIZE OR ELIMINATE ANY UNNECESSARY LAND DISTURBANCE OR CLEARING.

HAYBALE SPECIFICATIONS

- A. ALL HAYBALES SHALL BE EITHER WIRE OR STRING BOUND. HAYBALES SHALL BE INSTALLED SO THAT BINDINGS ARE ORIENTED ALONG THE SIDE RATHER THAN ALONG THE TOP AND BOTTOM OF THE BALES TO PREVENT DETERIORATION OF THE BINDINGS.
- B. GAPS BETWEEN HAYBALES SHALL BE CHINKED WITH STRAW TO PREVENT WATER FROM ESCAPING BETWEEN BALES.
- C. ON SLOPES WHERE SURFACE FLOW FOLLOWS THE HAYBALE LINE, PERPENDICULAR HAYBALE CHECKS SHALL BE INSTALLED AT 50 FOOT INTERVALS.
- D. HAYBALES SHOULD NEVER BE USED FOR ANY APPLICATION WHERE SEDIMENT AND EROSION PROTECTION IS REQUIRED FOR A PERIOD OF TIME LONGER THAN 3 MONTHS.
- E. HAYBALES SHOULD HAVE A MINIMUM WEIGHT OF 40 POUNDS AND A MAXIMUM WEIGHT OF 120 POUNDS.
- F. LINES OF HAYBALES SHOULD FOLLOW CONTOUR LINES 5-10 FEET DOWN GRADIENT FROM THE SLOPE. WHERE CONTOUR LINES CAN NOT BE FOLLOWED HAYBALES SHOULD BE STAGGERED AND PERPENDICULAR WINGS SHOULD BE PLACED AT 50 FOOT INTERVALS.
- G. HAYBALES SHOULD BE PLACED IN AN EXCAVATED TRENCH AT LEAST 4" DEEP.
- H. HAYBALE STAKES ARE TO BE MADE OUT OF HARDWOOD WITH A MINIMUM CROSS SECTIONAL AREA OF 1.5 SQUARE INCHES OR STEEL POSTS WITH A MINIMUM WEIGHT OF 0.5 POUNDS PER LINEAR FOOT.

SILT FENCE SPECIFICATIONS

8. PERMITTIVITY

A. SYNTHETIC FILTER FABRIC SHALL BE A PERVIOUS SHEET OF PROPYLENE, NYLON, POLYESTER, ETHYLENE, OR SIMILAR FILAMENTS AND SHALL BE CERTIFIED BY THE MANUFACTURER OR SUPPLIER AS CONFORMING TO THE FOLLOWING MINIMUM REQUIREMENTS:

FILTERING EFFICIENCY
 GRAB TENSILE STRENGTH
 ELONGATION AT FAILURE
 PERCENT (MIN)
 POUNDS
 PERCENT

4. MULLEN BURST STRENGTH 250 POUNDS PER SQUARE INCH

5. PUNCTURE STRENGTH 50 POUNDS6. APPARENT OPENING SIZE 0.60mm< X <0.90mm

7. FLOW RATE 0.2 GALLONS PER SQUARE FOOT PER MINUTE

0.05 PER SECOND (MIN)

9. ULTRAVIOLET RADIATION STABILITY 70 PERCENT AFTER 500 HOURS OF EXPOSURE (MIN)

- STAKES ARE TO BE MADE OUT OF HARDWOOD WITH A MINIMUM CROSS SECTIONAL AREA OF 1.5 SQUARE INCHES OR STEEL POSTS WITH A MINIMUM WEIGHT OF 0.5 POUNDS PER LINEAR FOOT.
- C. TORN OR PUNCTURED GEOTEXTILES SHALL NOT BE USED.
- ON SLOPES WHERE SURFACE FLOW FOLLOWS THE SILT FENCE LINE, PERPENDICULAR SILT FENCE CHECKS SHALL BE INSTALLED AT 50 FOOT INTERVALS.
- LINES OF SILT FENCE SHOULD FOLLOW CONTOUR LINES 5—10 FEET DOWN GRADIENT FROM THE SLOPE. WHERE CONTOUR LINES CAN NOT BE FOLLOWED PERPENDICULAR WINGS SHOULD BE PLACED AT 50 FOOT INTERVALS.

GENERAL NOTES

- 1. ALL UTILITIES SHALL BE APPROVED BY LOCAL UTILITY COMPANIES PRIOR TO CONSTRUCTION; ALL UTILITIES SHALL BE CONSTRUCTED TO UTILITY COMPANY
- 2. ALL CONSTRUCTION SHALL BE TO TOWN SPECIFICATIONS & REGULATIONS.
- 3. NO CHANGES CAN BE MADE TO THESE PLANS WITHOUT THE DESIGN ENGINEER'S APPROVAL. FIELD CHANGES SHALL HAVE PRIOR APPROVAL OF THE ENGINEER.
- 4. CONTRACTOR SHALL NOTIFY THE DESIGN ENGINEER OF CONSTRUCTION SCHEDULE SO THAT INSPECTION MAY BE PROVIDED.
- 6. UNDERGROUND UTILITY, STRUCTURE AND FACILITY LOCATIONS DEPICTED ON PLANS HAVE BEEN COMPILED, IN PART, FROM RECORD MAPPING SUPPLIED BY THE RESPECTIVE UTILITY COMPANIES OR GOVERNMENTAL AGENCIES, FROM PAROLE TESTIMONY, FIELD MEASUREMENTS AND FROM OTHER SOURCES. THESE LOCATIONS MUST BE CONSIDERED APPROXIMATE IN NATURE. ADDITIONALLY, OTHER SUCH FEATURES MAY EXIST ON THE SITE, THE EXISTENCE OF WHICH ARE UNKNOWN TO CHA COMPANIES. THE SIZE, LOCATION AND EXISTENCE OF ALL SUCH FEATURES MUST BE FIELD DETERMINED AND VERIFIED BY THE APPROPRIATE AUTHORITIES PRIOR TO CONSTRUCTION.
- 7. CONTACT "CALL BEFORE YOU DIG" AT 811 OR 1-800-922-4455 TWO (2) WORKING DAYS PRIOR TO THE START OF ANY CONSTRUCTION ACTIVITY.
- 8. FIRE LANES, IF REQUESTED BY THE FIRE MARSHAL, SHALL BE INSTALLED AND MAINTAINED ON SITE IN ACCORDANCE WITH TOWN ORDINANCE OR STANDARDS IN
- 9. THE CONTRACTOR SHALL NOTIFY THE TREE WARDEN BEFORE REMOVING OR PRUNING ANY TREES THAT STAND ON TOWN OF LISBON PROPERTY.
- 10. ALL CURB/HANDICAP RAMP DESIGNS SHALL CONFORM TO ANSI, ADA, CT BASIC BUILDING CODE, TOWN OF LISBON STANDARDS IN FORCE AS DIRECTED THE THE TOWN BUILDING OFFICIAL.

SUGGESTED SEEDING MIXTURES AND PRACTICES

AREAS WHERE SEED MIX APPLIES	SEEDING MIXTURES BY WEIG	SHT	RATE PER 1,000 SQ. FT.	SEEDING DATES
ALL LAWN AREAS	RED FESCUES KENTUCKY BLUEGRASS PERENNIAL RYEGRASS	45% 45% 10%	1 LBS.	APRIL 1 – JUNE 15 OR AUG. 15 – OCT. 1
ROAD CUTS, FILLS, DIVERSION DITCHES, & STORMWATER BASINS	KENTUCKY TALL FESCUE REDTOP CREEPING RED FESCUE	47% 6% 47%	0.95 LBS.	APRIL 1 — JUNE 15 OR AUG. 15 — OCT. 1

WHERE TREES ARE TO BE RETAINED, THE SEED MIXTURE SHOULD BE ADAPTED FOR SHADY CONDITIONS.

TEMPORARY SEEDING	ANNUAL RYEGRASS OR PERENNIAL RYEGRASS	1-1/2 LBS.	WITHIN 7 DAYS AFTER SUSPENSION OF GRADING WORK

PERSON RESPONSIBLE FOR MAINTAINING CONTROL MEASURES DURING CONSTRUCTION.

NAME

DAVID NOWAKOWSKI

ADDRESS

15 KENYON ROAD, LISBON, CT

TELEPHONE # (860)-376-1081

MAINTENANCE LOG

FINAL STABILIZATION

LOCATION	DESCRIPTION	DATE	INITIALS
PROJECT DATES	•	DATE	INITIALS
PROJECT GROUNDE	BREAKING		


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101 East River Drive, 1st Floor
East Hartford, CT 06108
860-885-1055 | www.chacompanies.com

SITE DEVELOPMENT PLAN PREPARED FOR:

DAVID NOWAKOWSKI

SUNFOX CAMPGROUND 15 KENYON ROAD LISBON, CONNECTICUT

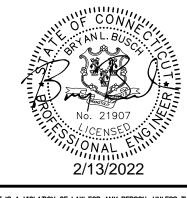

IT IS A WOLATION OF LAW FOR ANY PERSON, UNLESS THEY ARE ACTING UNDER THE DIRECTION OF A LICENSED PROFESSIONAL ENGINEER, ARCHITECT, LANDSCAPE ARCHITECT OR LAND SURVEYOR TO ALIER AN ITEM IN ANY WAY, IF AN ITEM BEARING THE STAMP OF A LICENSED PROFESSIONAL IS ALTERED, THE ALTERING ENGINEER, ARCHITECT OR LANDSCAPE ARCHITECT OR LAND SURVEYOR SHALL STAMP THE DOCUMENT AND INCLUDE THE NOTATION "ALTERED BY" FOLLOWED BY THEIR SIGNATURE, THE DATE OF SUCH ALTERATION, AND A SPECIFIC DESCRIPTION OF THE ALTERATION.

No. Submittal / Revision App'd. By Date

EROSION &
SEDIMENTATION
CONTROL
NARRATIVE & NOTES

Designed By: Drawn By: Checked By
KLD/PMP ZBC/RAC

Issue Date: Project No: Scale:


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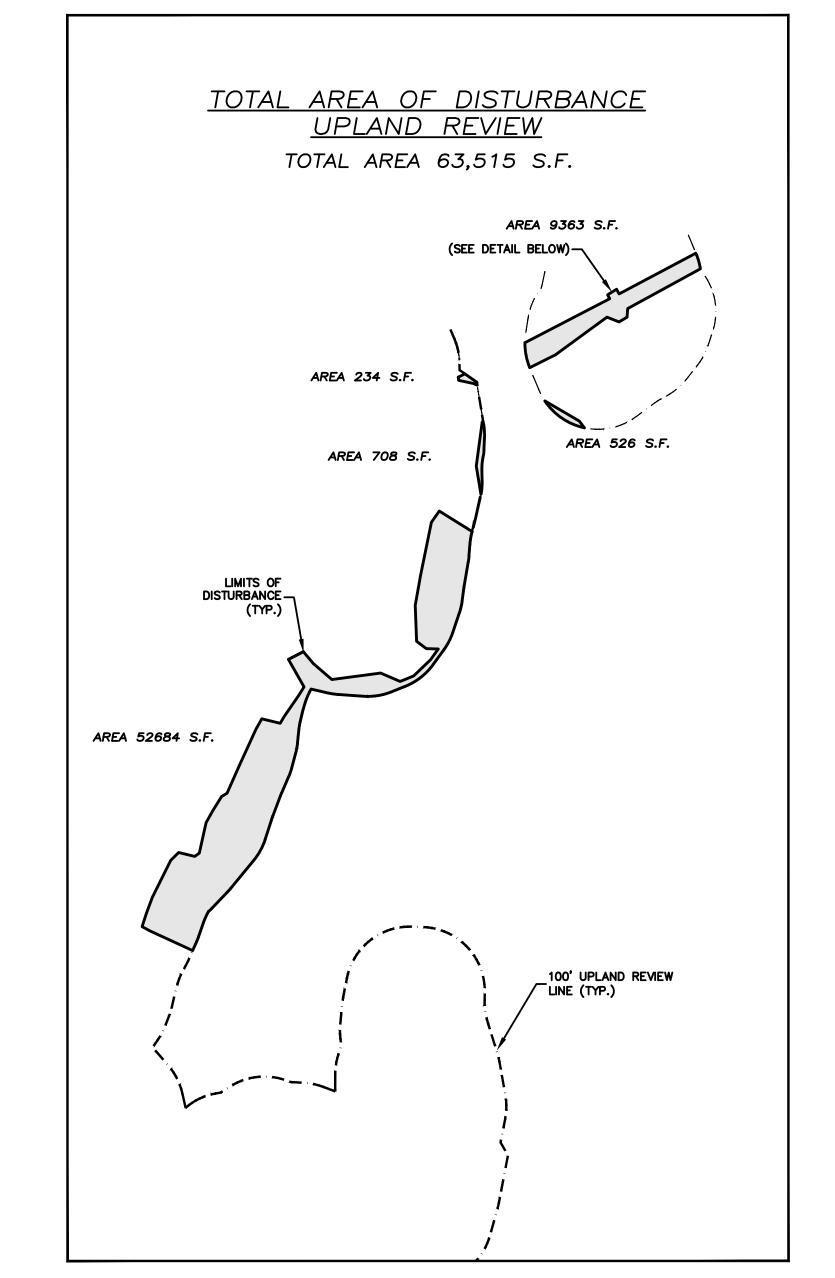
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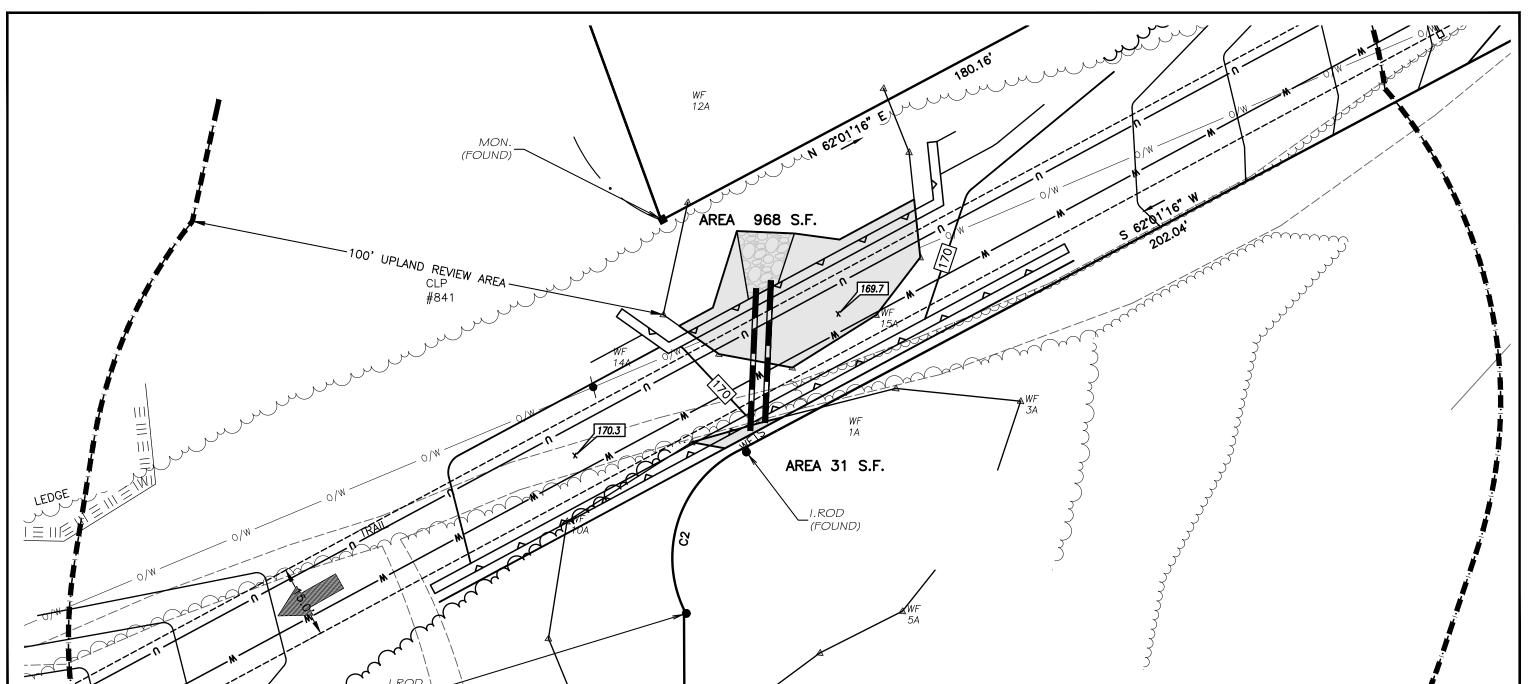
063591

SHEET 10

AS NOTE





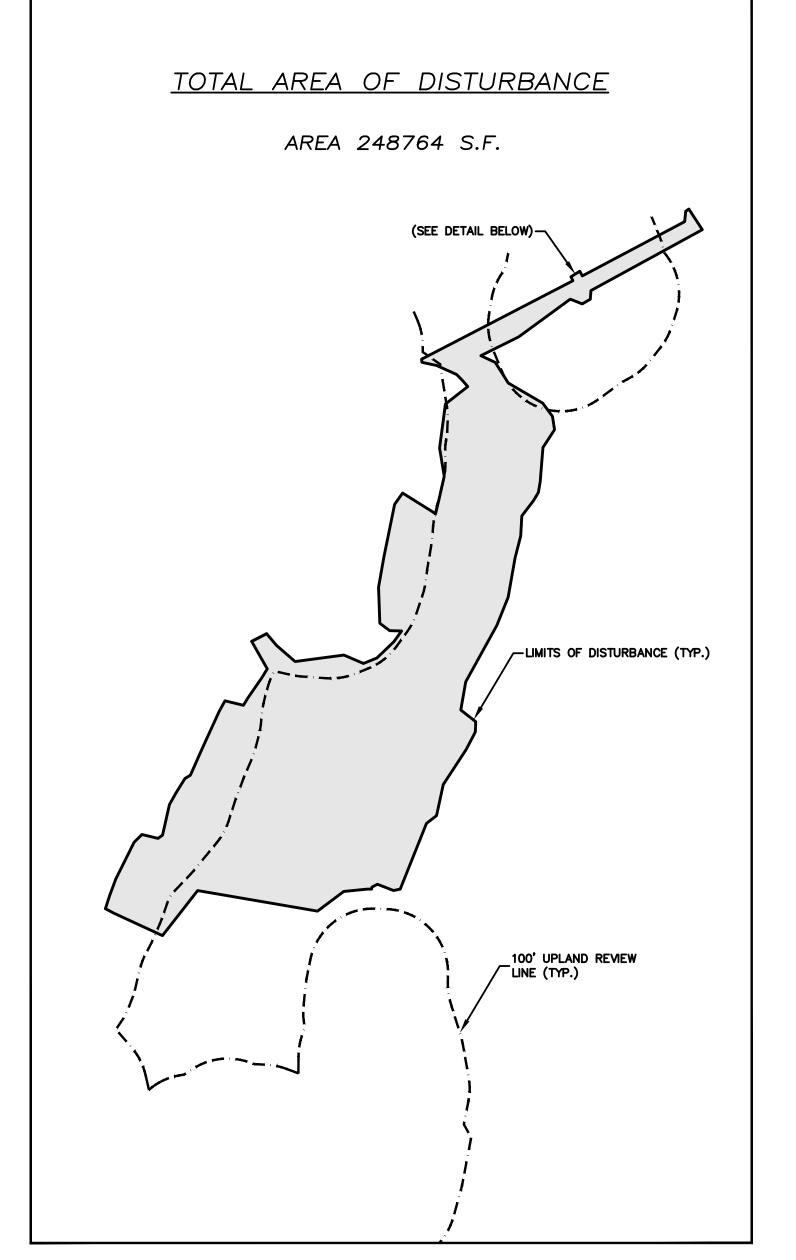

WETLAND IMPACT AREA DETAIL

TOTAL AREA 1084.82 S.F.

CRAPHIC SCALE IN FEET

LEGEND

	<u>LEGEND</u>	
PROPERTY LIN	 E	
ABUTTERS LIN	E	
EDGE OF PAV	EMENT	
EDGE OF GRA	VEL	
EXISTING CON	TOUR	——————————————————————————————————————
STONE WALL		·
RETAINING WAI	LL	
LIMITS OF INL	AND WETLANDS	<u></u>
FENCE		— X X X
TREELINE		. ~ ~ ~ ~ ~ .
PROPOSED CL	EARING LIMIT	.~~~~~.
PROP UNDERC	GROUND WATER	w
PROP UNDERC	ROUND ELECTRIC	——— E ———
PROP UNDERC	GROUND CABLE/TV	T
PROP UNDERC	GROUND FUTURE UTILITY	U
FLOOD ZONE	LIIMIT	
100' UPLAND	REVIEW LINE	
NOW OR FORM	MERLY	N/F
UTILITY POLE		
BOUNDARY PO	DINT	©
IRON MONUME	INT	•
STONE MONUN	MENT	
		+
TEST PIT		


PERC HOLE

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No. Submittal / Revision App'd. By Date

IMPACT ESTIMATES

Designed By: Drawn By: Checked By: KLD/PMP ZBC/RAC

Issue Date: Project No: Scale:

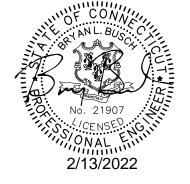Drawing No.:

SHEET 11