
MUNICIPAL SIDEWALK IMPROVEMENTS

Town of Lisbon, Connecticut Thomas Sparkman - First Selectman State Project No. 0072-0085



INDEX TO DRAWINGS

DRAWING No.	DESCRIPTION OF DRAWING	
1	Town Hall Sidewalk Improvements	
2	Strawberry Fields Sidewalk Improvements 26+00 - 37+00	
3	Strawberry Fields Sidewalk Improvements 37+00 - End	
4	Community Center Sidewalk Improvements	
5	ADD - ALTERNATE 1 - Central School	
	Sidewalk Improvements	
6	Construction Details & Notes	
7	Construction Details & Notes	

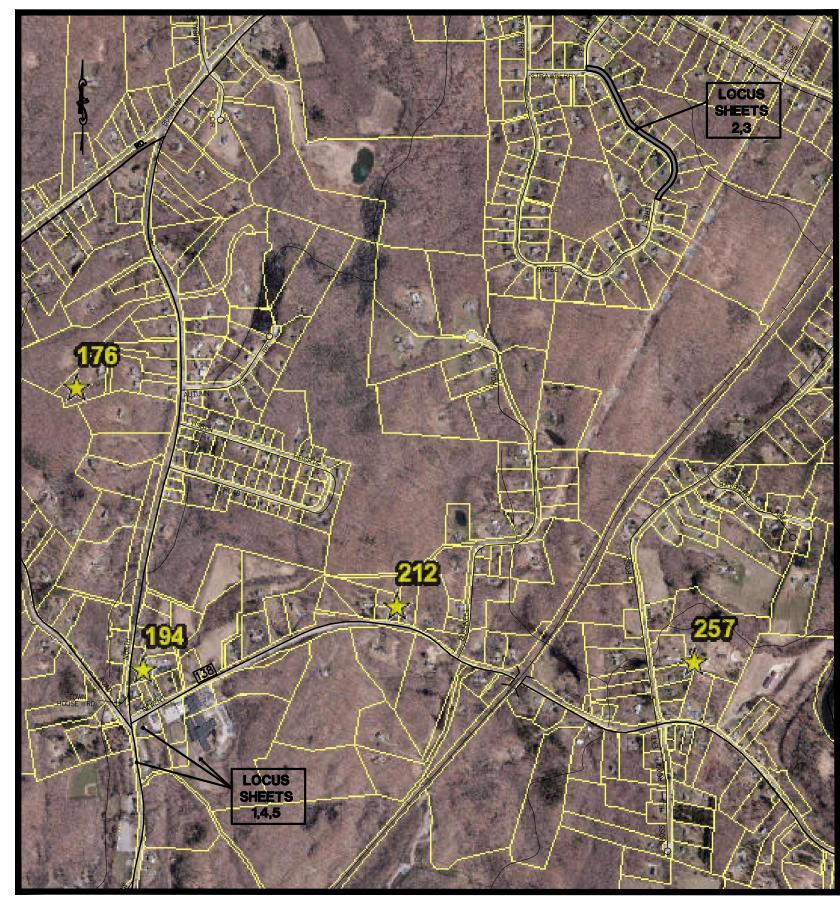

LOCATION MAP

REVISED: MARCH 6, 2024 REVISED: JANUARY 12, 2024 REVISED: SEPTEMBER 19, 2023 REVISED: SEPTEMBER 14, 2023

CLA Engineers, Inc. CIVIL • STRUCTURAL • SURVEYING 317 Main Street Norwich, CT 06360



LEGEND TO DRAWINGS

EXISTING SEWER & MANHOLE COVER

EDGE OF WETLANDS

FLARED END UNIT

MANHOLE

CATCHBASIN

DRILL HOLE

IRON PIN, IRON PIPE

EXISTING WATER SERVICE/MAIN & VALVE AND SHUTOFF


MERE STONE, Conn. HIGHWAY MONUMENT, CONC. MONUMENT


GOVERNING SPECIFICATION: PROJECT MANUAL & SPECIFICATIONS **AUGUST 19, 2023** MUNICIPAL SIDEWALK IMPROVEMENTS PROJECT NO. 0072-0085


(860) 886-1966 Fax (860) 886-9165


TOWN OF LISBON

REVISED: JANUARY 12,2024

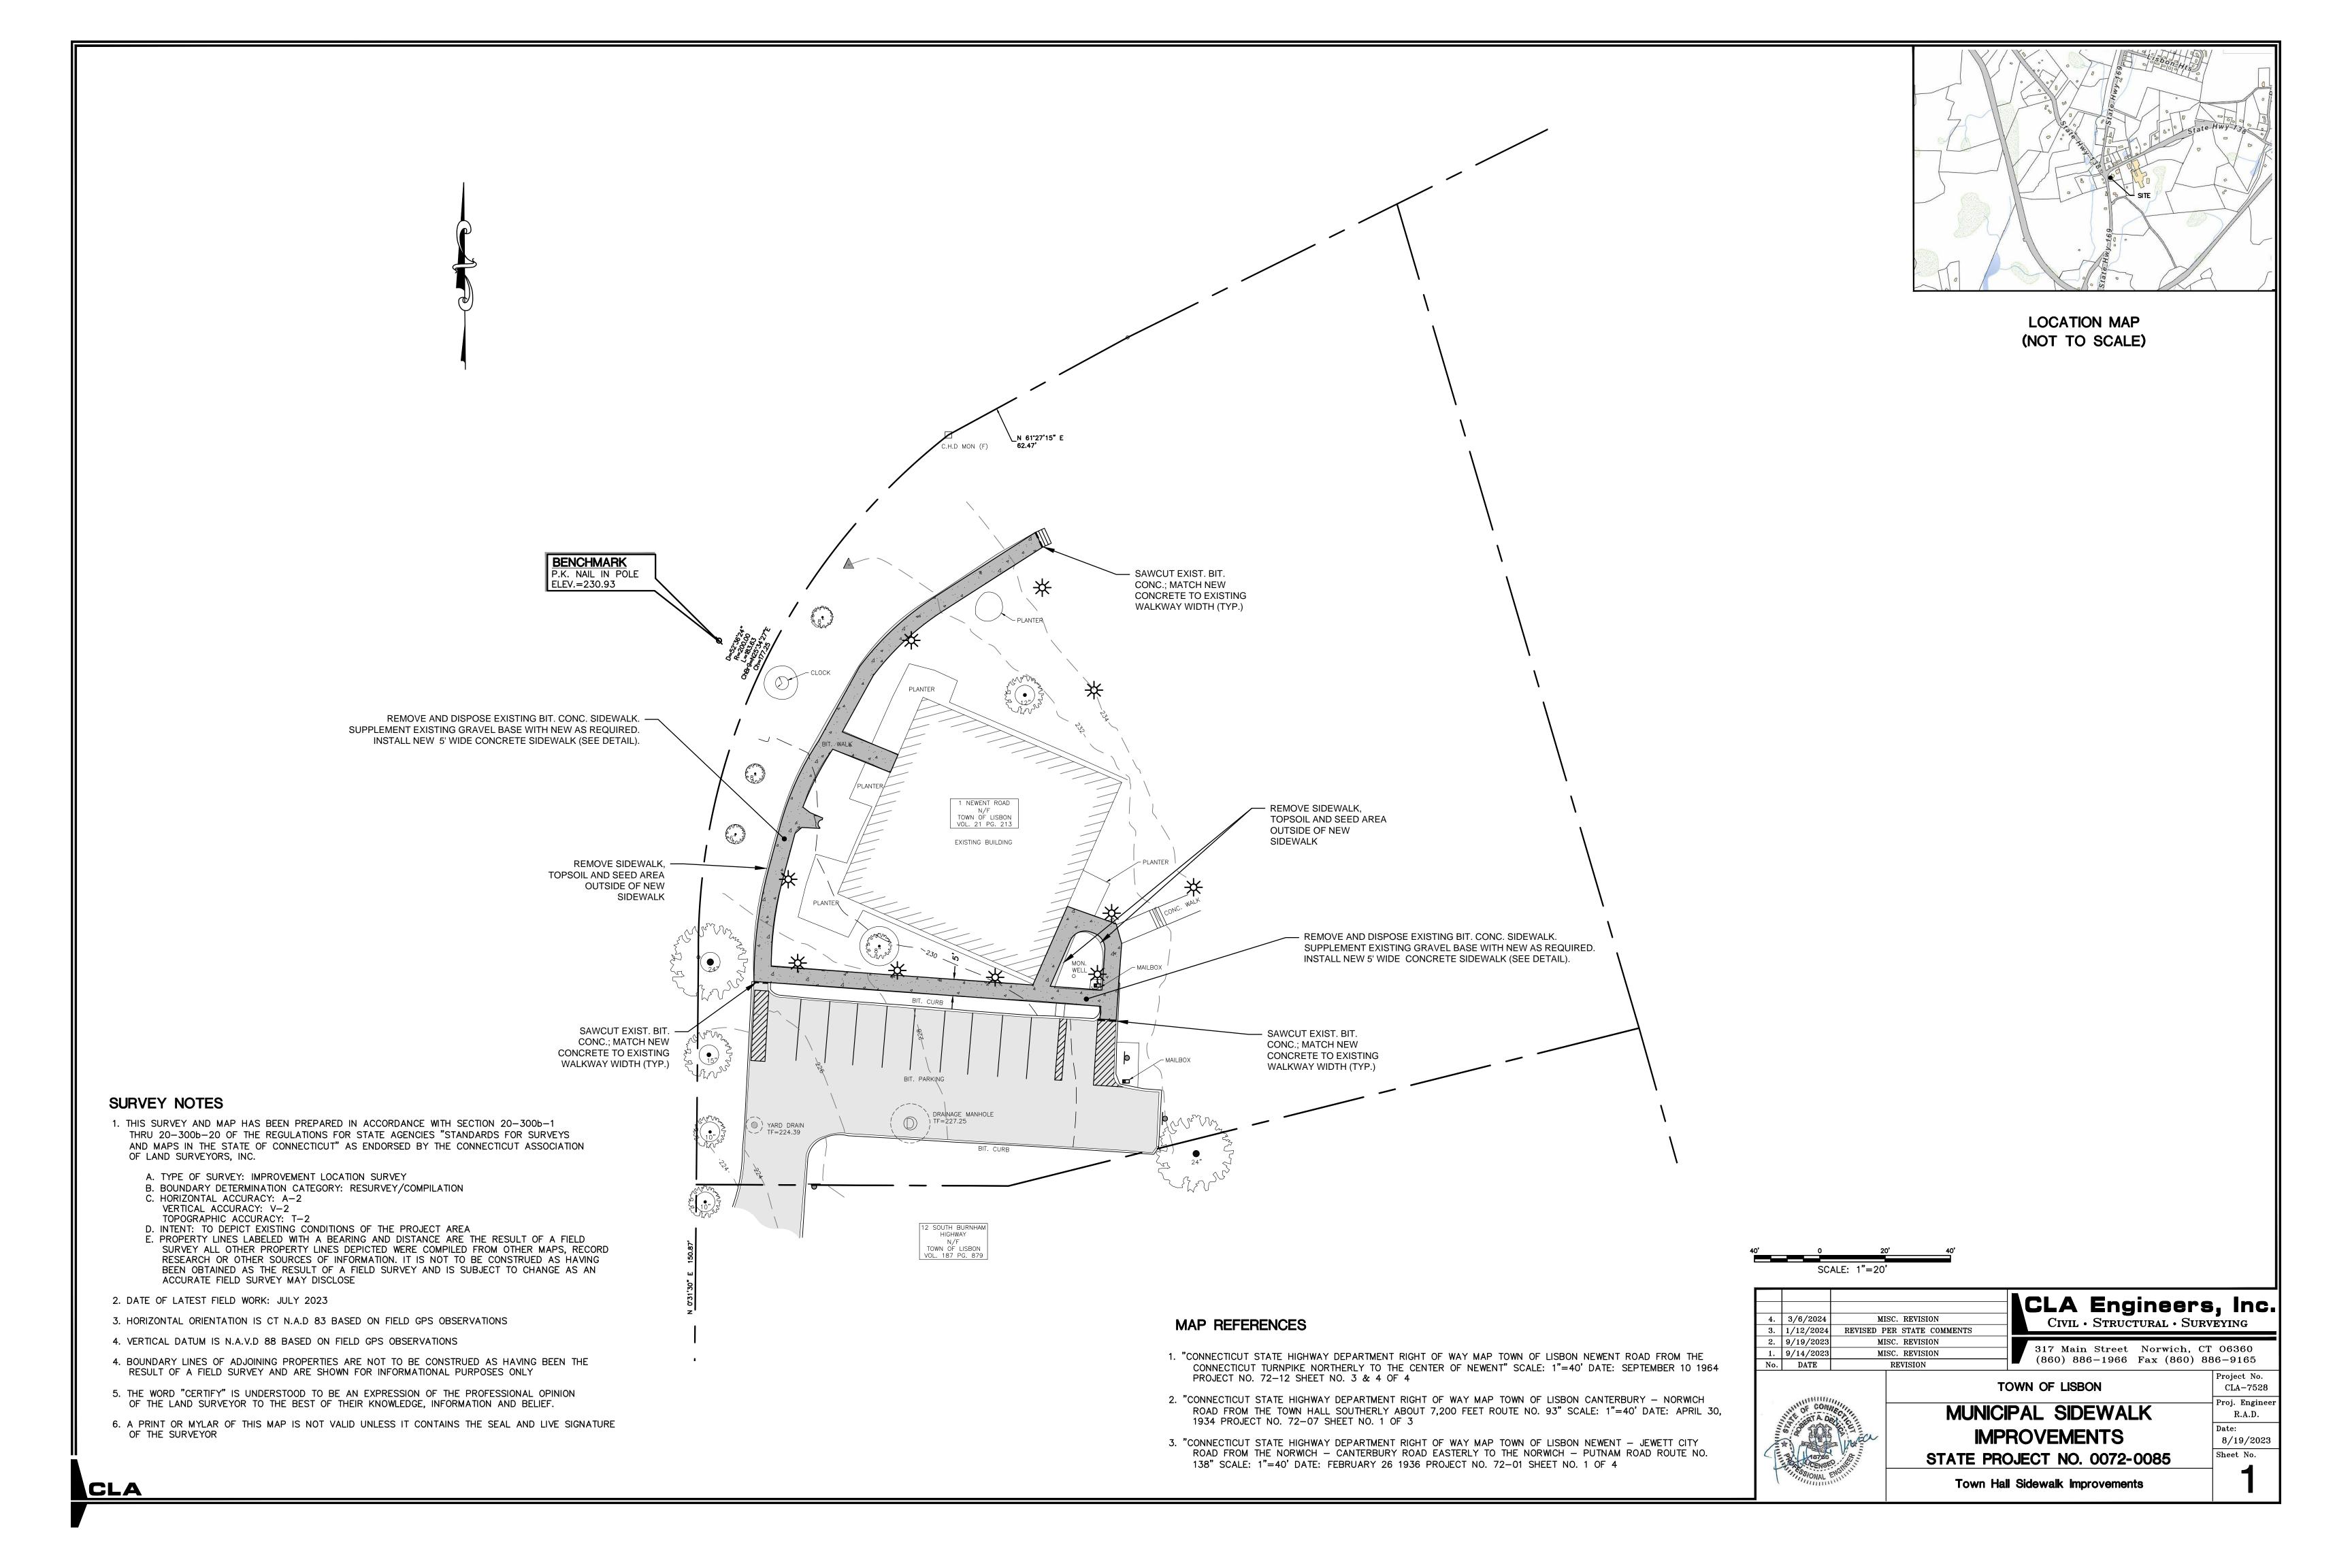


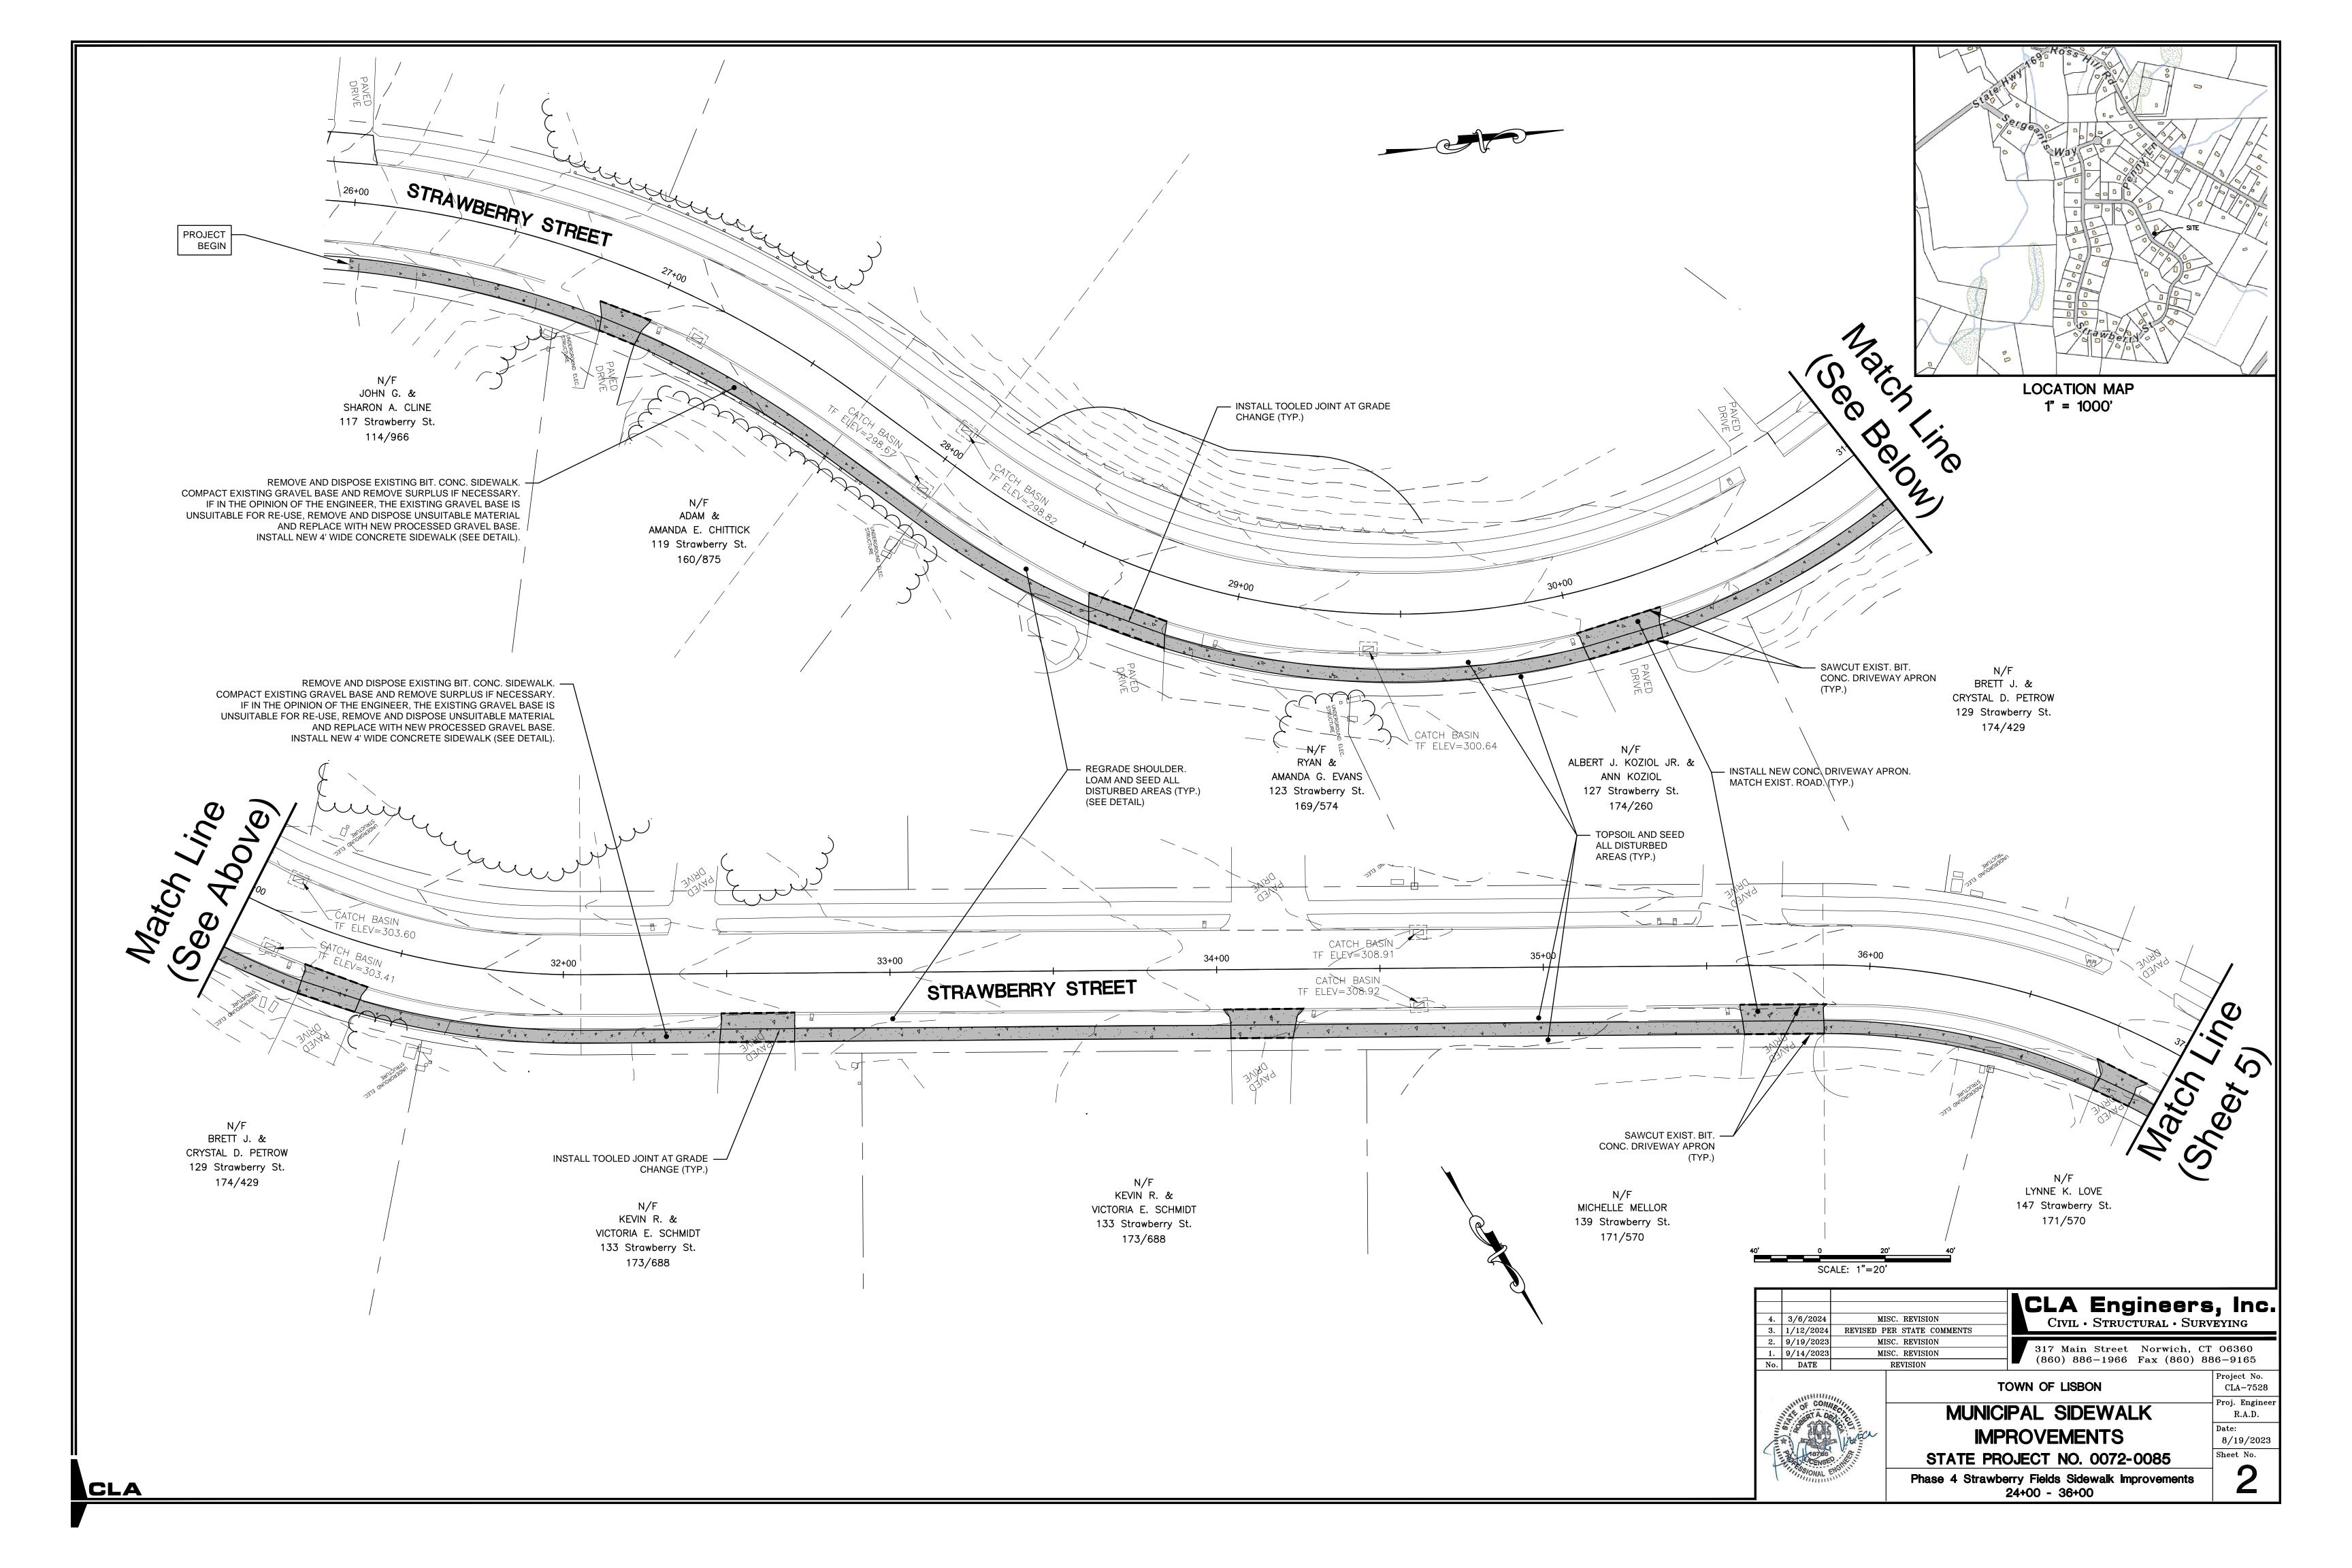

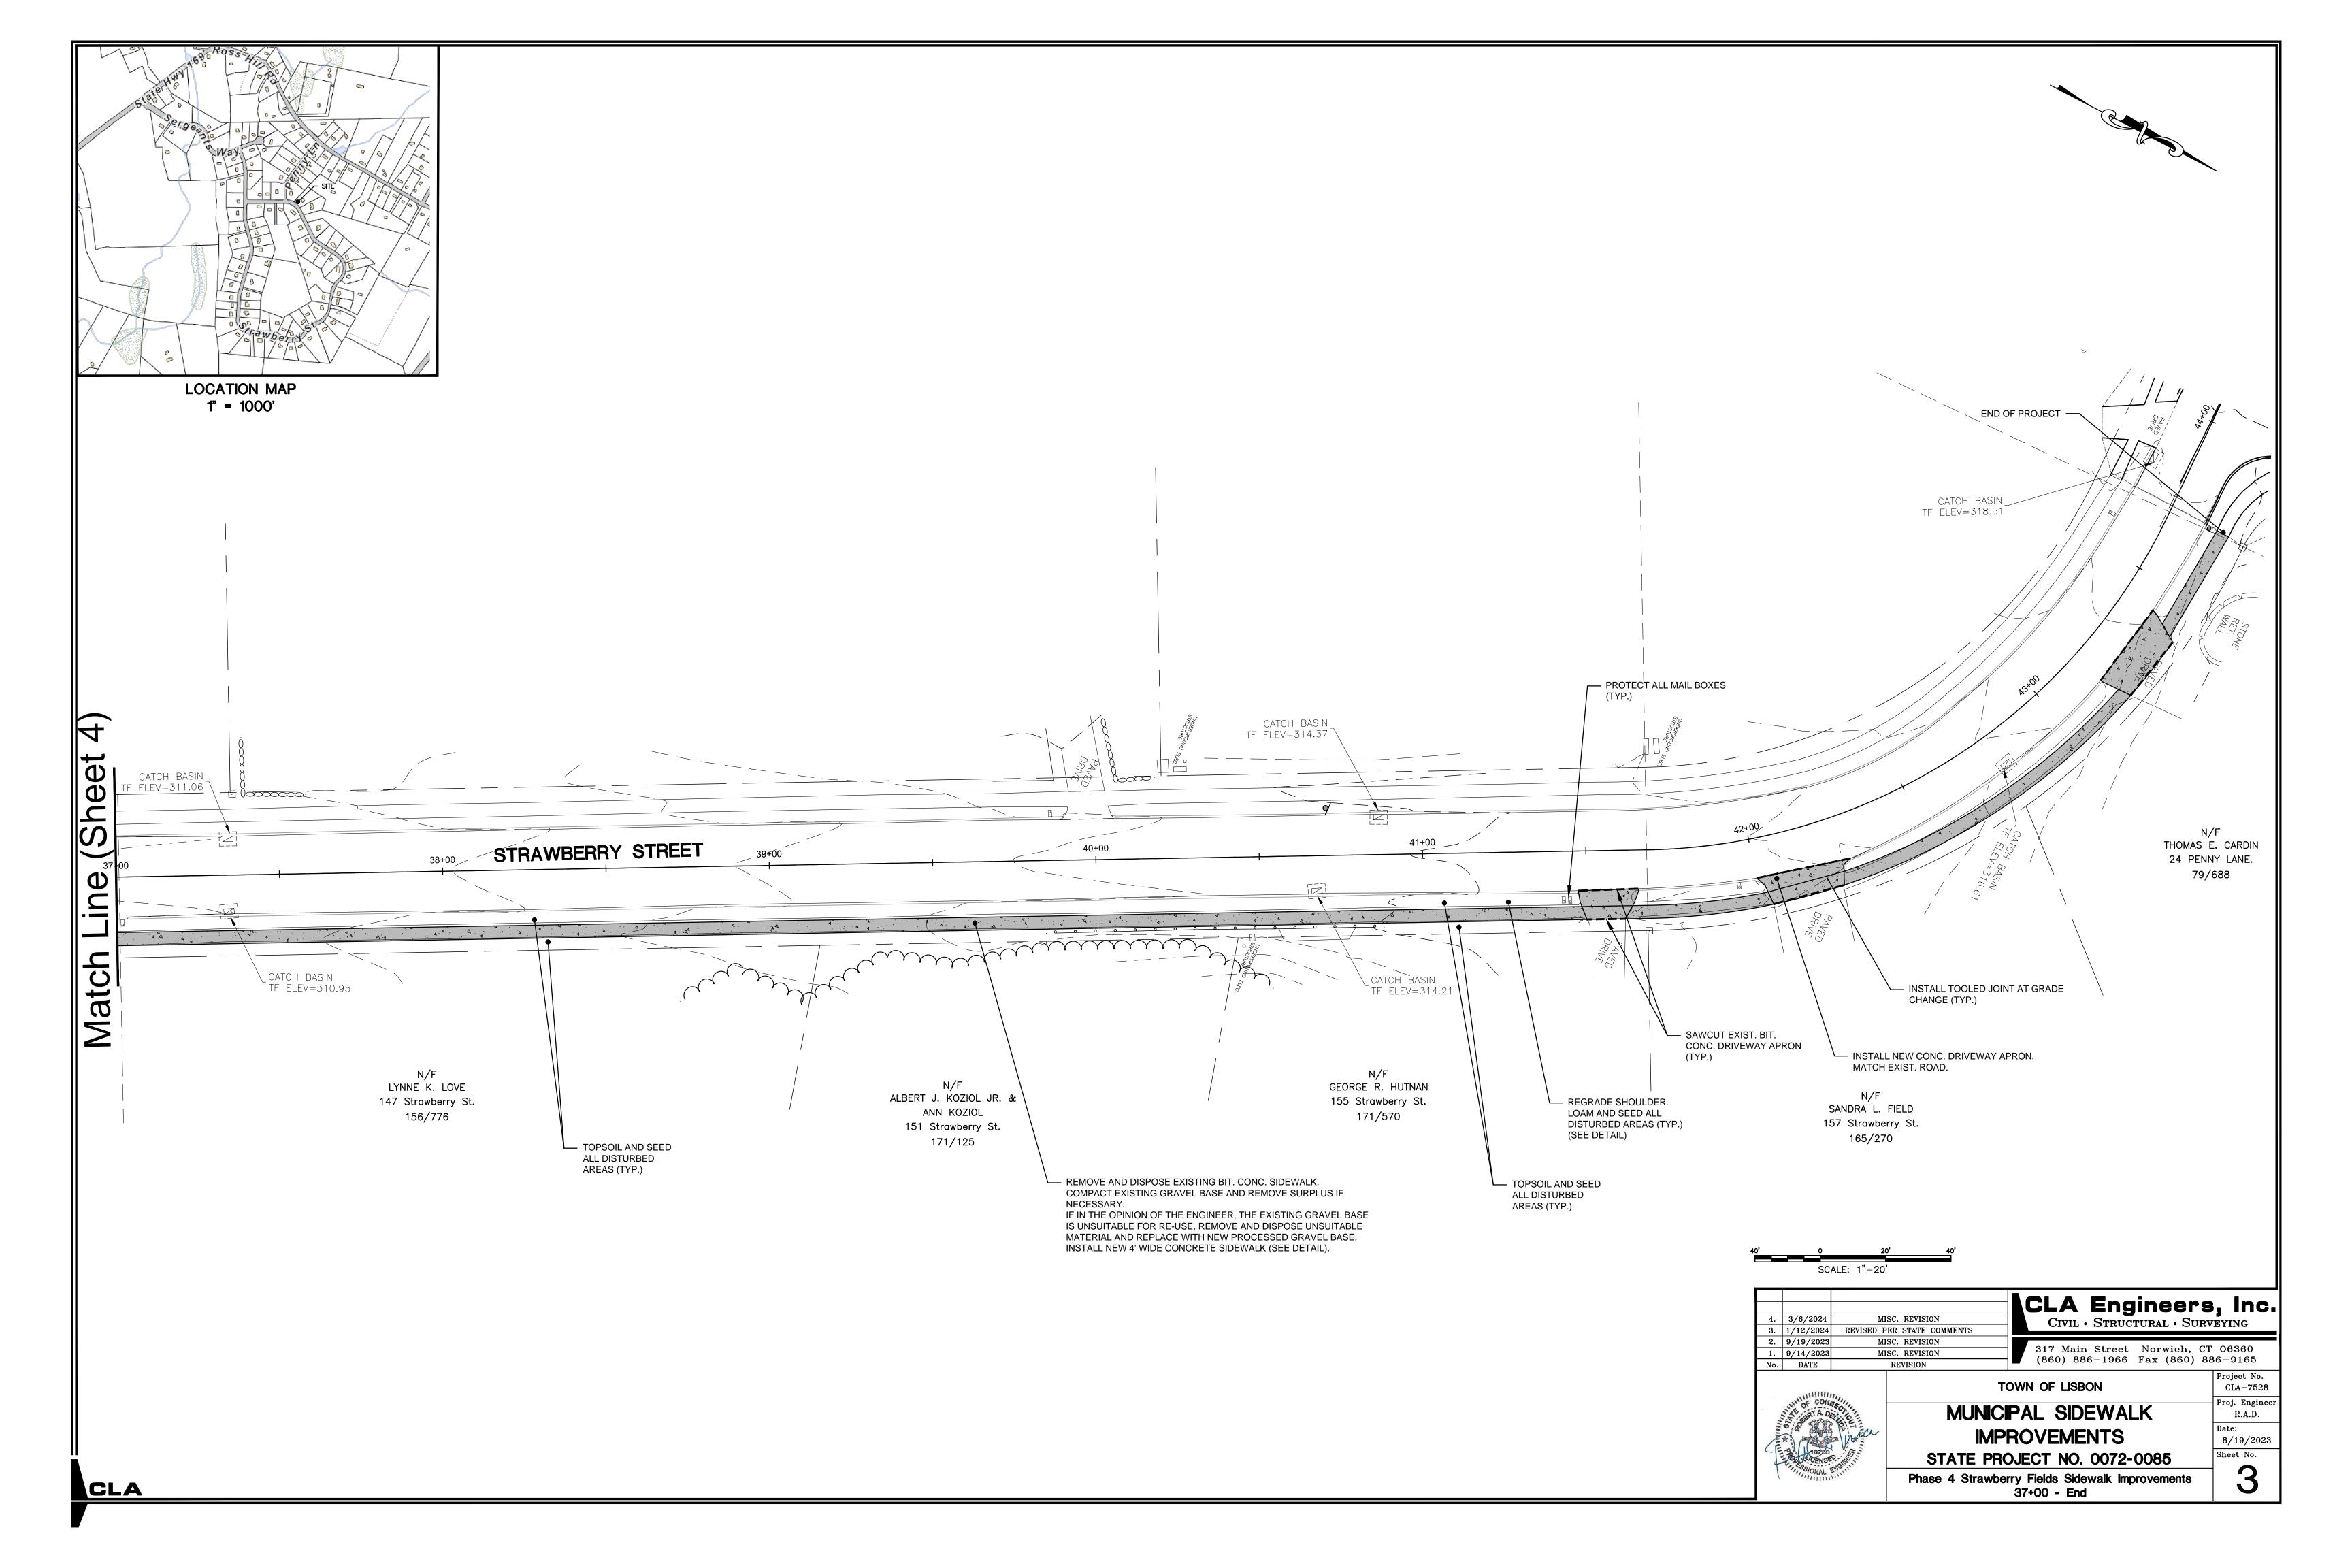

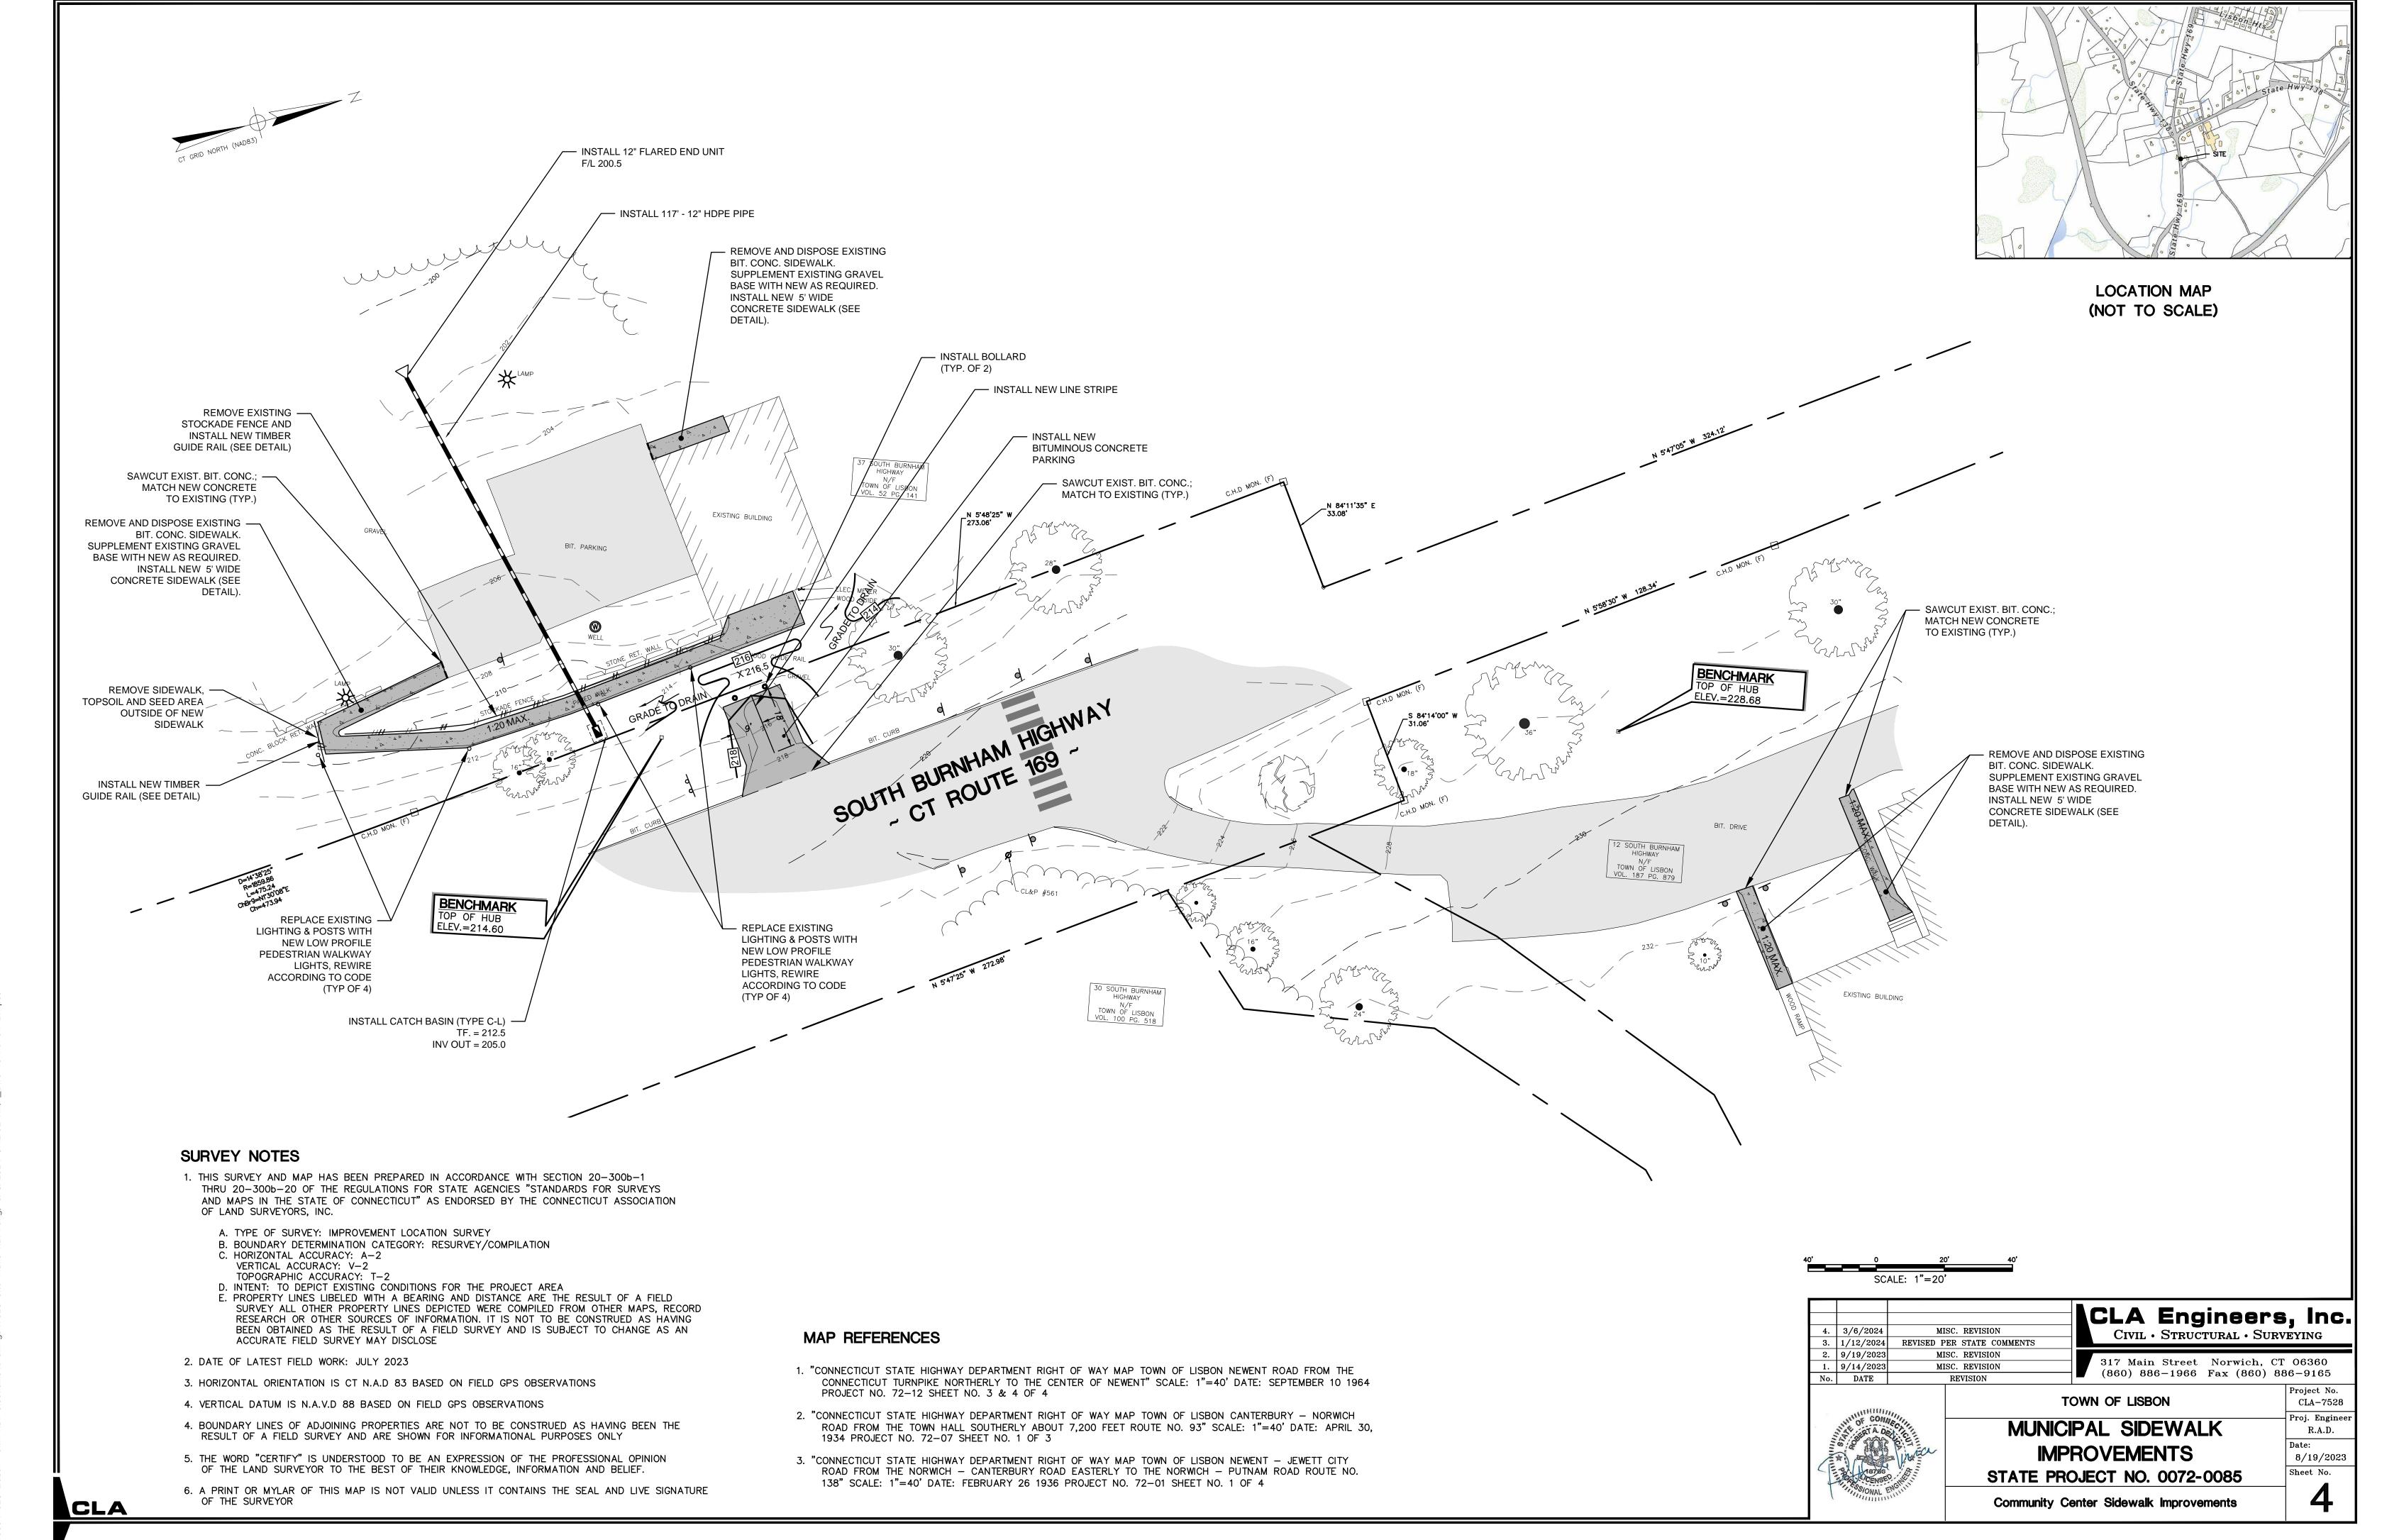


M:\7000\7500\7528 Lisbon Town Hall Sidewalks\Drawings\7528 Site Plans REV4.dwg. 3/8/2024 8:42:52 AM. DWG To PDF64 BIT.pc3

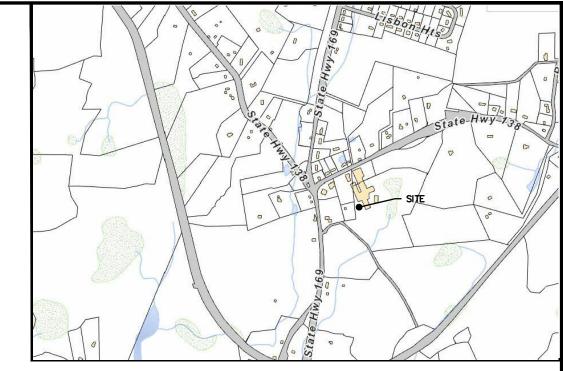

LOCATION MAP

(NOT TO SCALE)

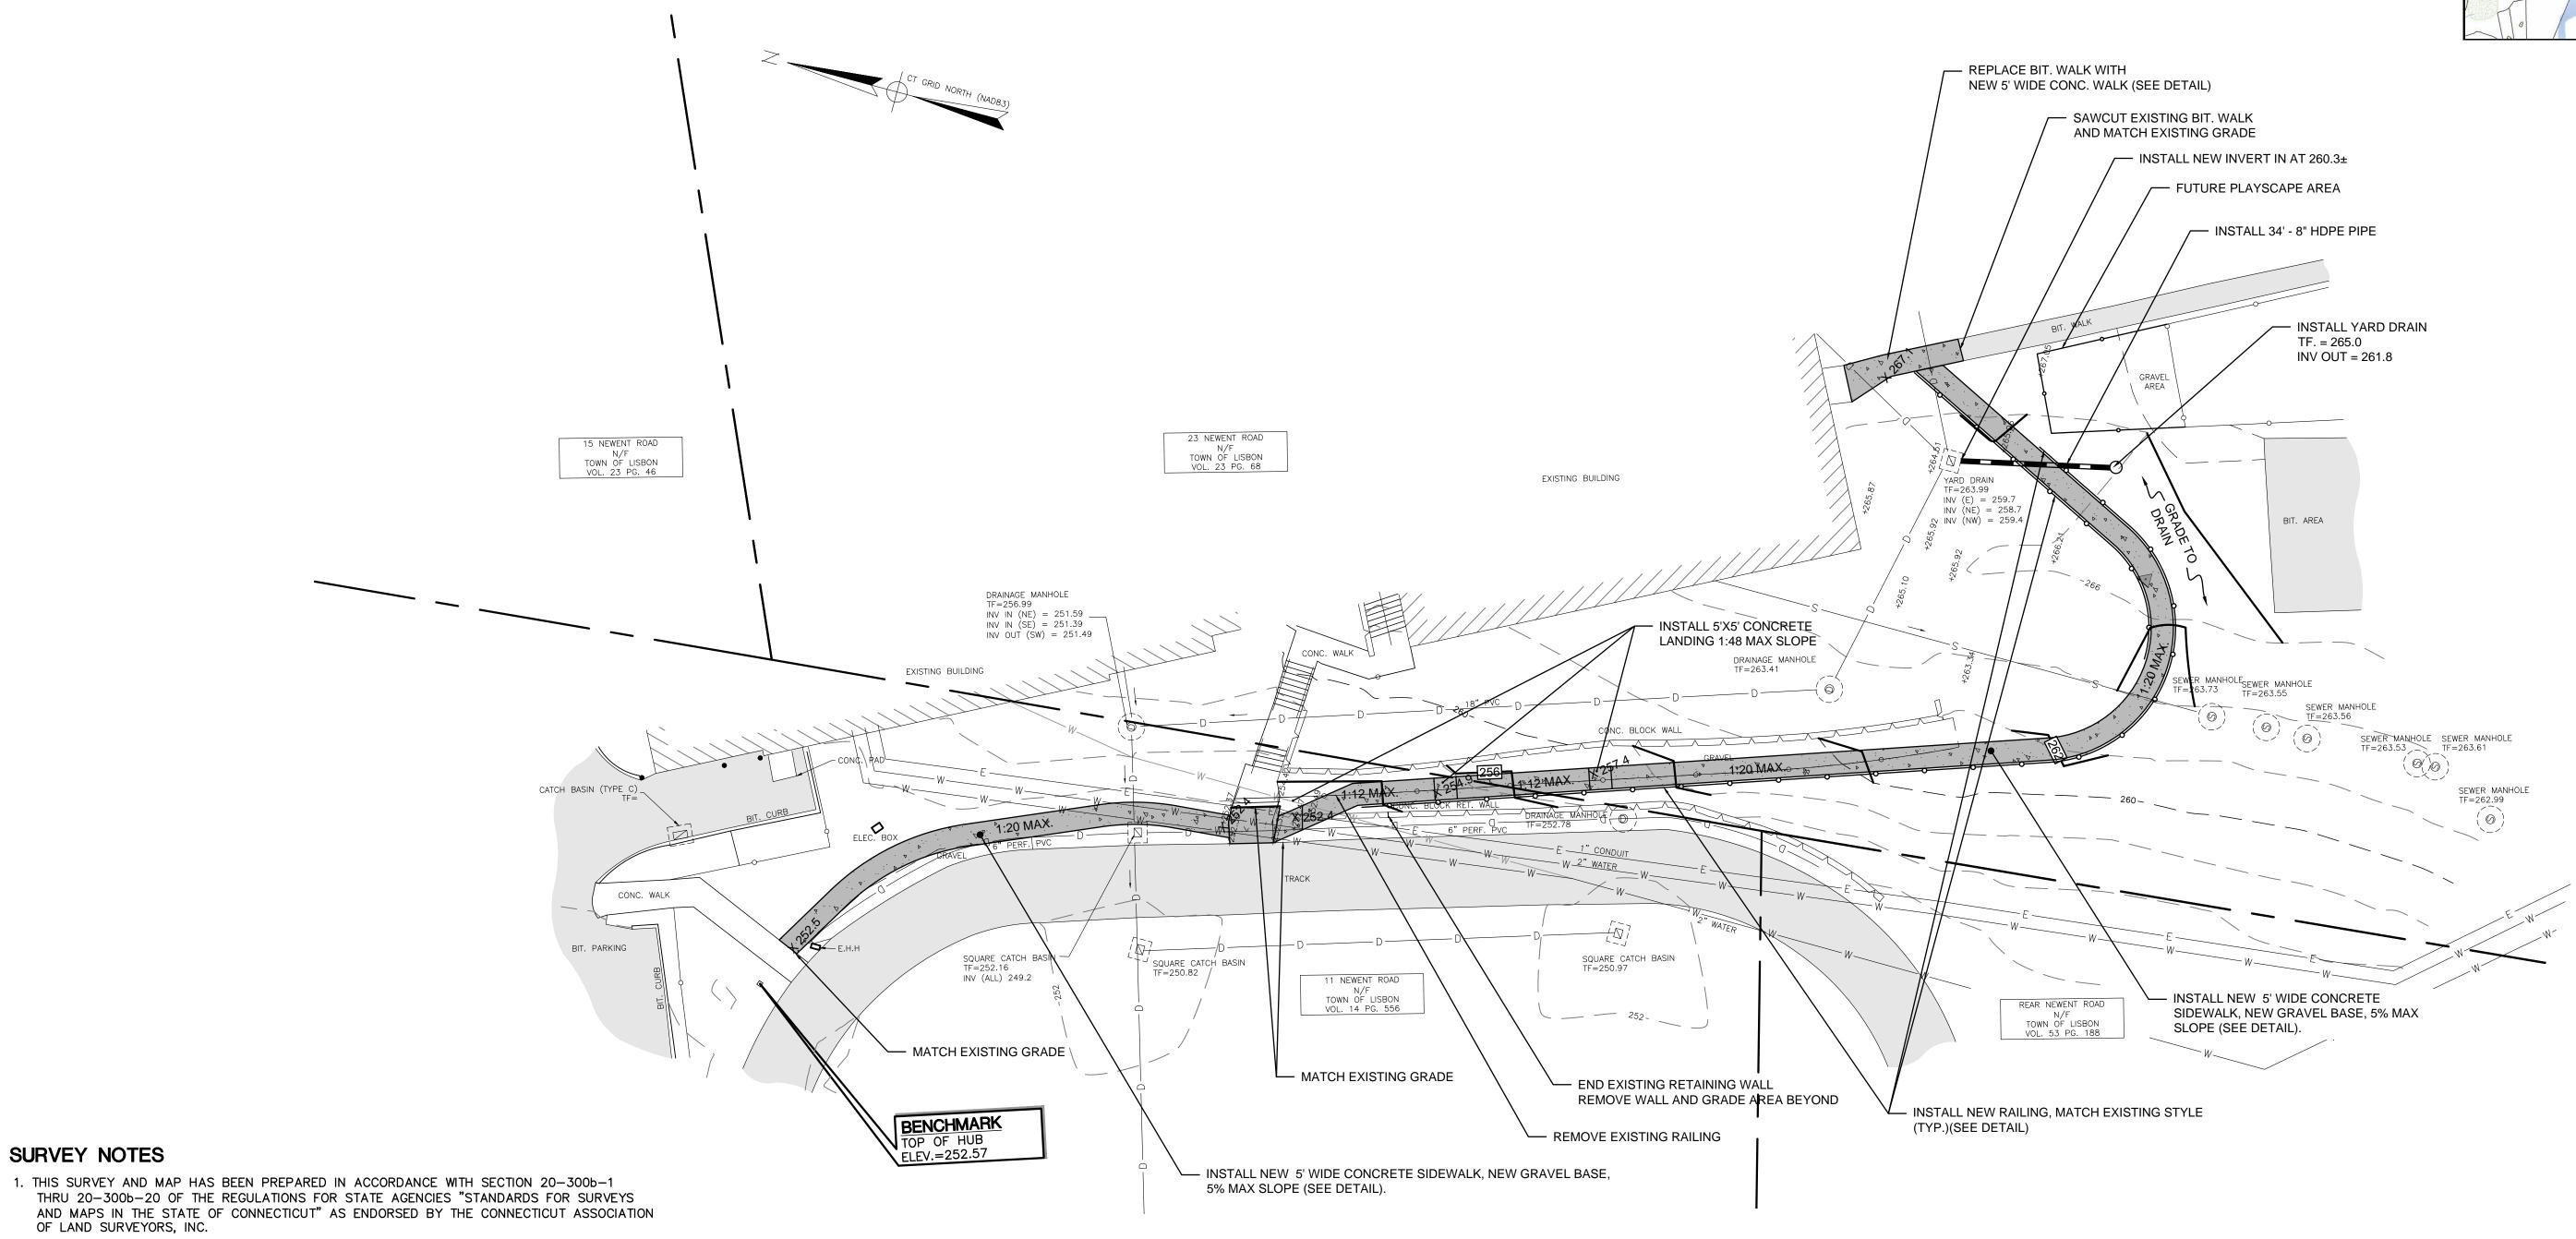

MAP REFERENCES

- 1. "CONNECTICUT STATE HIGHWAY DEPARTMENT RIGHT OF WAY MAP TOWN OF LISBON NEWENT ROAD FROM THE CONNECTICUT TURNPIKE NORTHERLY TO THE CENTER OF NEWENT" SCALE: 1"=40' DATE: SEPTEMBER 10 1964 PROJECT NO. 72-12 SHEET NO. 3 & 4 OF 4
- 2. "CONNECTICUT STATE HIGHWAY DEPARTMENT RIGHT OF WAY MAP TOWN OF LISBON CANTERBURY NORWICH ROAD FROM THE TOWN HALL SOUTHERLY ABOUT 7,200 FEET ROUTE NO. 93" SCALE: 1"=40' DATE: APRIL 30, 1934 PROJECT NO. 72-07 SHEET NO. 1 OF 3
- 3. "CONNECTICUT STATE HIGHWAY DEPARTMENT RIGHT OF WAY MAP TOWN OF LISBON NEWENT JEWETT CITY ROAD FROM THE NORWICH - CANTERBURY ROAD EASTERLY TO THE NORWICH - PUTNAM ROAD ROUTE NO. 138" SCALE: 1"=40' DATE: FEBRUARY 26 1936 PROJECT NO. 72-01 SHEET NO. 1 OF 4

CLA Engineers, Inc.

CIVIL · STRUCTURAL · SURVEYING MISC. REVISION 4. 3/6/2024 3. 1/12/2024 REVISED PER STATE COMMENTS 2. 9/19/2023 317 Main Street Norwich, CT 06360 (860) 886-1966 Fax (860) 886-9165 1. 9/14/2023 MISC. REVISION No. DATE REVISION TOWN OF LISBON



MUNICIPAL SIDEWALK **IMPROVEMENTS**

CLA-7528

Proj. Enginee

R.A.D.

8/19/2023 Sheet No.

STATE PROJECT NO. 0072-0085 ADD - ALTERNATE 1 Central School Sidewalk Improvements

CLA

SURVEY NOTES

OF THE SURVEYOR

OF LAND SURVEYORS, INC.

C. HORIZONTAL ACCURACY: A-2 VERTICAL ACCURACY: V-2 TOPOGRAPHIC ACCURACY: T-2

SURVEY MAY DISCLOSE

2. DATE OF LATEST FIELD WORK: JULY 2023

A. TYPE OF SURVEY: IMPROVEMENT LOCATION SURVEY B. BOUNDARY DETERMINATION CATEGORY: COMPILATION

D. INTENT: TO DEPICT EXISTING CONDITIONS OF THE PROJECT AREA

3. HORIZONTAL ORIENTATION IS CT N.A.D 83 BASED ON FIELD GPS OBSERVATIONS

4. VERTICAL DATUM IS N.A.V.D 88 BASED ON FIELD GPS OBSERVATIONS

E. THIS PLAN WAS COMPILED FROM OTHER MAPS, RECORD RESEARCH OR OTHER SOURCES OF INFORMATION. IT IS NOT TO BE CONSTRUED AS HAVING BEEN OBTAINED AS THE RESULT OF A FIELD SURVEY AND IS SUBJECT TO CHANGE AS AN ACCURATE FIELD

4. BOUNDARY LINES OF ADJOINING PROPERTIES ARE NOT TO BE CONSTRUED AS HAVING BEEN THE

6. A PRINT OR MYLAR OF THIS MAP IS NOT VALID UNLESS IT CONTAINS THE SEAL AND LIVE SIGNATURE

5. THE WORD "CERTIFY" IS UNDERSTOOD TO BE AN EXPRESSION OF THE PROFESSIONAL OPINION

OF THE LAND SURVEYOR TO THE BEST OF THEIR KNOWLEDGE, INFORMATION AND BELIEF.

RESULT OF A FIELD SURVEY AND ARE SHOWN FOR INFORMATIONAL PURPOSES ONLY

- 2. THE PROPOSED LOCATIONS OF SILTATION AND EROSION CONTROL MEASURES ARE SHOWN ON THE PLANS. THE CONTRACTOR SHALL PROVIDE SILT FENCE, STONE CHECK DAMS AND/OR OTHER EROSION CONTROL MEASURES AS NEEDED OR DIRECTED BY THE ENGINEER OR TOWN STAFF TO ADEQUATELY PREVENT SEDIMENT TRANSPORT.
- 3. EROSION AND SEDIMENTATION CONTROL MEASURES SHALL BE INSTALLED PRIOR TO SITE DISTURBANCE. TOWN STAFF SHALL REVIEW AND APPROVE THE INSTALLATION PRIOR TO EXCAVATION
- 4. THE CONTRACTOR SHALL INSPECT, REPAIR AND/OR REPLACE EROSION CONTROL MEASURES EVERY 7 DAYS AND IMMEDIATELY FOLLOWING ANY SIGNIFICANT RAINFALL OR SNOW MELT. SEDIMENT DEPOSITS MUST BE REMOVED WHEN WHEN DEPOSITS REACH APPROXIMATELY ONE HALF THE HEIGHT OF THE BARRIER. SEDIMENT CONTROL DEVICES SHALL REMAIN IN PLACE AND BE MAINTAINED BY THE CONTRACTOR UNTIL AREAS UPSLOPE ARE PERMANENTLY STABILIZED.
- 5. STAKED HAY BALE SILT BARRIERS OR SILT FENCE SHALL BE INSTALLED AROUND ANY TEMPORARY STOCKPILE AREAS. TEMPORARY VEGETATIVE COVER MAY BE REQUIRED (SEE
- 6. INLET SEDIMENTATION CONTROL DEVICES SHALL BE INSTALLED UNDER THE GRATES OF ALL NEW CATCH BASINS AT THE TIME OF INSTALLATION, AND UNDER THE GRATES OF EXISTING CATCH BASINS IN THE CONSTRUCTION AREA.
- 7. CONTINUOUS DUST CONTROL USING WATER, CALCIUM CHLORIDE OR APPROVED EQUAL SHALL BE PROVIDED FOR ALL EARTH STOCKPILES, EARTH PILED ALONG EXCAVATIONS, SURFACES OF BACKFILLED TRENCHES AND GRAVELED ROADWAY SURFACES.
- 8. IF DEWATERING IS NECESSARY DURING ANY TIME OF CONSTRUCTION A CLEAR WATER DISCHARGE SHALL BE PROVIDED.
- 9. ALL DISTURBED AREAS SHALL BE RESTORED PER THE SLOPE STABILIZATION AND PERMANENT VEGETATION DETAILS. ALL DISTURBED AREAS THAT ARE SLOPED LESS THAN THREE HORIZONTAL TO ONE VERTICAL (3:1) SLOPE SHALL BE LOAMED, SEEDED, FERTILIZED AND MULCHED PER THE PERMANENT VEGETATIVE COVER SPECIFICATIONS. EROSION CONTROL MATTING SHALL BE PROVIDED ON ALL DISTURBED AREAS WITHIN 10 FEET OF THE STREAM BED AND THAT ARE SLOPED MORE THAN THREE HORIZONTAL TO ONE VERTICAL (3:1).
- 10. IF FINAL SEEDING OF DISTURBED AREAS IS NOT TO BE COMPLETED BEFORE OCTOBER 15, THE CONTRACTOR SHALL PROVIDE TEMPORARY MULCHING (DORMANT SEEDING MAY BE ATTEMPTED AS WELL) TO PROTECT THE SITE AND DELAY PERMANENT SEEDING.
- 11. WHEN FEASIBLE, TEMPORARY SEEDING OF DISTURBED AREAS THAT HAVE NOT BEEN FINISHED GRADED SHALL BE COMPLETED PRIOR TO OCTOBER 15.
- 12. ANY EROSION WHICH OCCURS WITHIN THE DISTURBED AREAS SHALL BE IMMEDIATELY REPAIRED AND STABILIZED. DURING THE CONSTRUCTION PHASE, INTERCEPTED SEDIMENT SHALL BE RETURNED TO THE SITE. POST SEEDING, INTERCEPTED SEDIMENT, IF ANY, SHALL BE DISPOSED OF IN A MANNER APPROVED BY THE TOWN AND ENGINEER.
- 13. EROSION AND SEDIMENTATION CONTROL MEASURES SHALL REMAIN IN PLACE UNTIL VEGETATION IS RE-ESTABLISHED OR SLOPES ARE STABILIZED AND REMOVAL IS APPROVED BY THE TOWN.
- 14. UNFORESEEN PROBLEMS WHICH ARE ENCOUNTERED IN THE FIELD SHALL BE SOLVED ACCORDING TO THE "2002 CONNECTICUT GUIDELINES FOR SOIL EROSION AND SEDIMENT CONTROL" BY THE CONNECTICUT COUNCIL ON SOIL AND WATER CONSERVATION IN COOPERATION WITH THE CONNECTICUT DEEP."
- 15. THE CONTRACTOR SHALL PROVIDE THE NAME AND EMERGENCY CONTACT INFORMATION FOR THE PROJECT PERSONNEL RESPONSIBLE FOR EROSION AND SEDIMENTATION CONTROLS.

PERMANENT VEGETATIVE COVER


TOPSOIL WILL BE REPLACED ONCE THE EXCAVATIONS HAVE BEEN COMPLETED AND THE SLOPES ARE GRADED AS SHOWN ON THE PLANS. PROVIDE SLOPE PROTECTION AS CALLED FOR ON THE PLANS AND DETAILS. TOPSOIL SHALL BE SPREAD AT A MINIMUM COMPACTED DEPTH OF 4 INCHES. ONCE THE TOPSOIL HAS BEEN SPREAD, ALL STONES TWO INCHES OR LARGER IN ANY DIMENSION WILL BE REMOVED AS WELL AS DEBRIS, APPLY AGRICULTURAL GROUND LIMESTONE AT THE RATE OF TWO TONS PER ACRE OR 100 LBS. PER 1000 S.F. APPLY 10-10-10 FERTILIZER OR EQUIVALENT AT A RATE OF 300 LBS. PER ACRE OR 7.5 LBS. PER S.F.. WORK LIMESTONE INTO THE SOIL TO A DEPTH OF 6 INCHES. INSPECT SEEDBED BEFORE SEEDING. IF TRAFFIC HAS COMPACTED THE SOIL, RETILL COMPACTED AREAS. APPLY THE FOLLOWING GRASS SEED MIX:

SEED MIXTURE

3:1 SLOPES OR GREATER DEEP SEED MIX NO. 3:	LBS./ACRE	LBS./1000 S.F.
CREEPING RED FESCUE (PENNLAWN, WINTERGREEN) BIRD'S FOOT TREFOIL (EMPIRE, VIKING) W/ INOCULANT	20 8	0.45 0.20
TALL FESCUE (KENTUCKY 31) OR SMOOTH BROMEGRASS (SARATOGA, LINCOLN)	<u>20</u> 45	<u>0.45</u> 1.00
REMAINDER OF DISTURBED AREAS	LBS./ACRE	LBS./1000 S.F.
KENTUCKY BLUEGRASS CREEPING RED FESCUE PERENNIAL RYEGRASS	20 20 5	0.45 0.45 <u>0.10</u>

- THE RECOMMENDED SEEDING DATES ARE:
- · APRIL 1 JUNE 15 · AUGUST 15 - OCTOBER 15

IMMEDIATELY FOLLOWING SEEDING, FIRM SEED BED WITH A ROLLER AND MULCH WITH WEED FREE STRAW. IF PERMANENT VEGETATIVE COVER IS HAS NOT BEEN ESTABLISHED BY SEPTEMBER 30, APPLY A TEMPORARY VEGETATIVE COVER ON THE TOPSOIL.

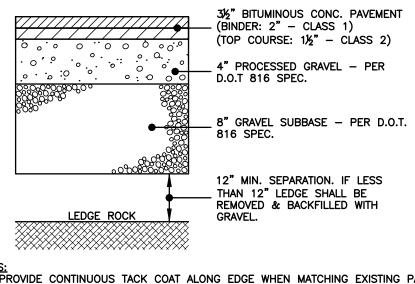



NOTES:

1. PROVIDE CONTINUOUS TACK COAT ALONG EDGE WHEN MATCHING EXISTING PAVEMENT
2. CONTRACTOR TO PROVIDE COMPACTION ON ALL TRENCH BACKFILLS, EXCAVATIONS AND PAVEMENT BASES TO NOT LESS THAN 95% OF THE DRY DENSITY FOR THAT MATERIAL WHEN TESTED IN ACCORDANCE WITH AASHTO T180, METHOD D


TYPICAL PAVEMENT SECTION DETAIL

NOT TO SCALE

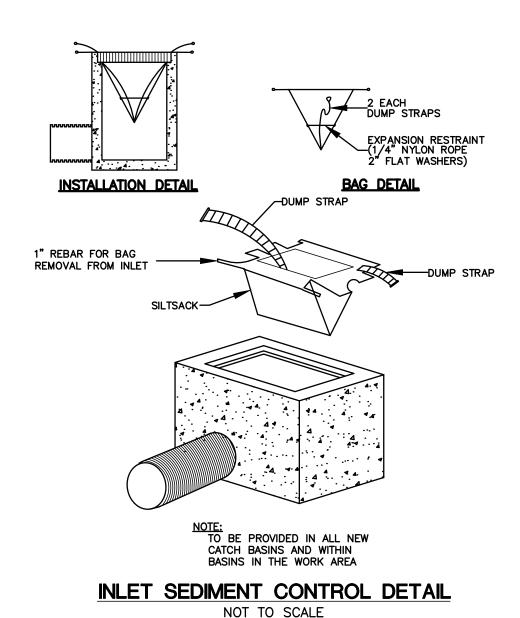

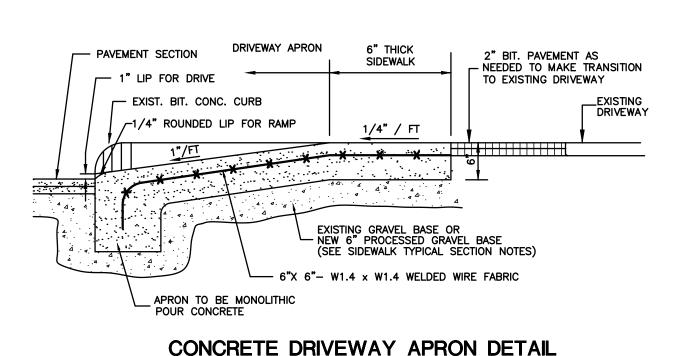



NOT TO SCALE

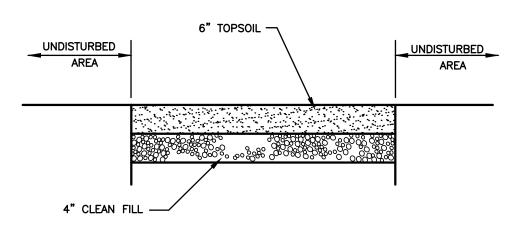


TOPSOIL & SEED CROSS-SECTION DETAIL

NOT TO SCALE

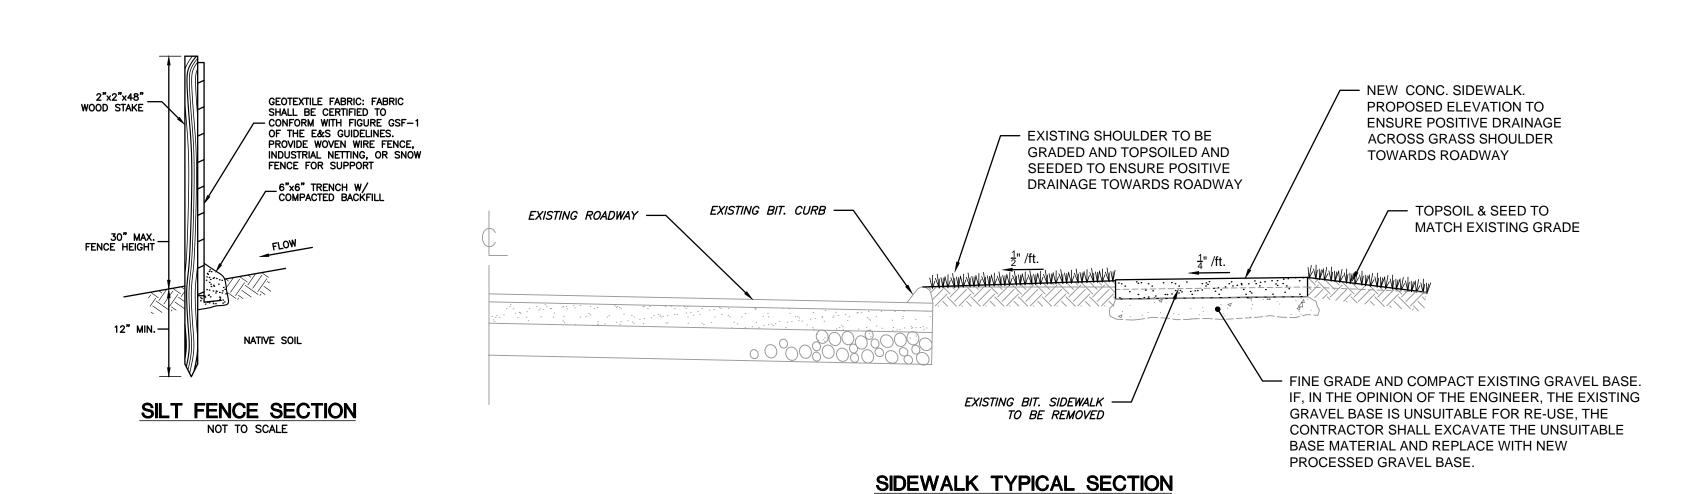


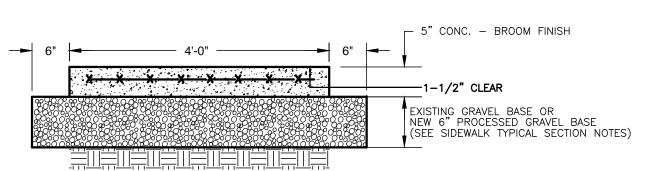


CROSS SECTION

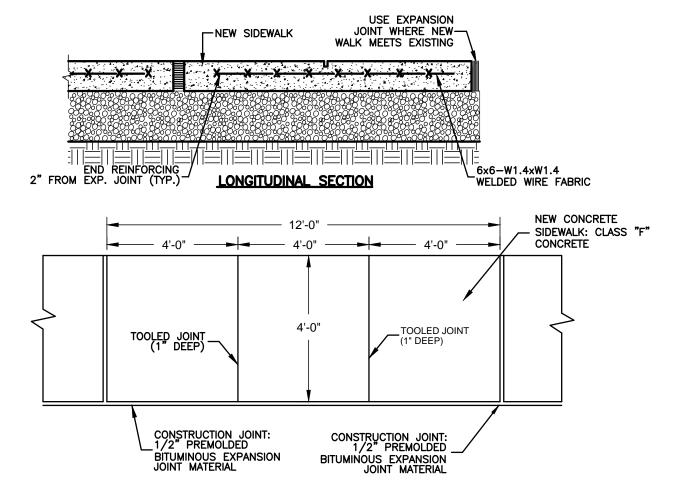

CONCRETE WALK & JOINT DETAIL (STRAWBERRY FIELDS)

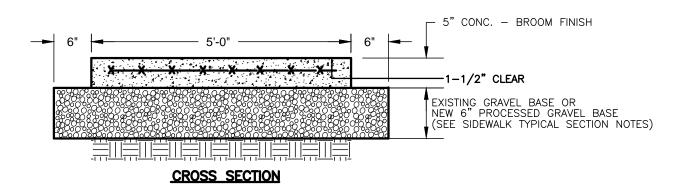

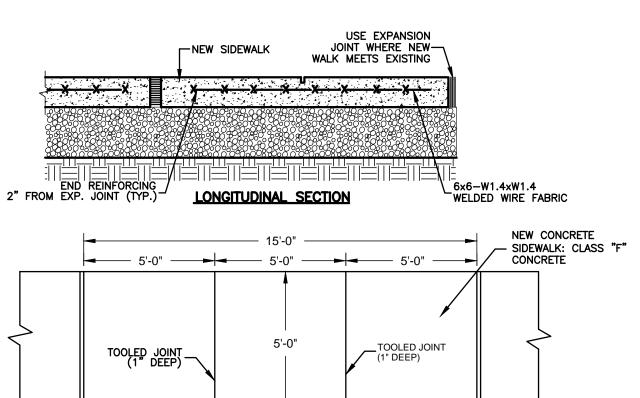

CONCRETE WALK & JOINT DETAIL

(TOWN HALL, COMMUNITY CENTER, MIDDLE SCHOOL)

NOT TO SCALE

CONSTRUCTION JOINT: 1/2" PREMOLDED

BITUMINOUS EXPANSION JOINT MATERIAL

CONSTRUCTION JOINT: 1/2" PREMOLDED


BITUMINOUS EXPANSION JOINT MATERIAL


CLA Engineers, Inc. 4. 3/6/2024MISC. REVISION CIVIL • STRUCTURAL • SURVEYING REVISED PER STATE COMMENTS 3. | 1/12/2024 2. 9/19/2023 MISC. REVISION 317 Main Street Norwich, CT 06360 1. 9/14/2023 MISC. REVISION (860) 886-1966 Fax (860) 886-9165 No. DATE REVISION TOWN OF LISBON CLA-7528 Proj. Enginee MUNICIPAL SIDEWALK R.A.D. **IMPROVEMENTS** 8/19/2023 Sheet No. STATE PROJECT NO. 0072-0085 Construction Details & Notes

- YARD DRAIN SHALL BE NYLOPLAST DRAIN BASIN WITH STANDARD GRATE
 MANUFACTURED BY ADS OR APPROVED EQUAL
 GRATES SHALL BE DUCTILE IRON PER ASTM A536 GRADE 70-50-05.
 FRAMES SHALL BE DUCTILE IRON PER ASTM A536 GRADE 70-50-05.
 DRAINAGE CONNECTION STUB JOINT TIGHTNESS SHALL CONFORM TO ASTM D3212 FOR CORRUGATED HDPE (ADS N-12/HANCOR DUAL WALL),
- N-12 HP, & PVC SEWER (4" 24").


 4. ADAPTERS CAN BE MOUNTED ON ANY ANGLE 0° TO 360°. 5. FOR LIGHT DUTY LOADING (NON-TRAFFIC)

YARD DRAIN DETAIL NOT TO SCALE

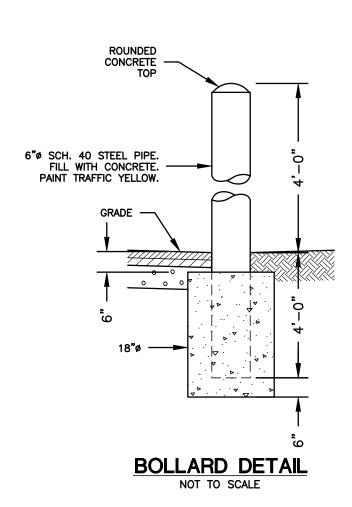


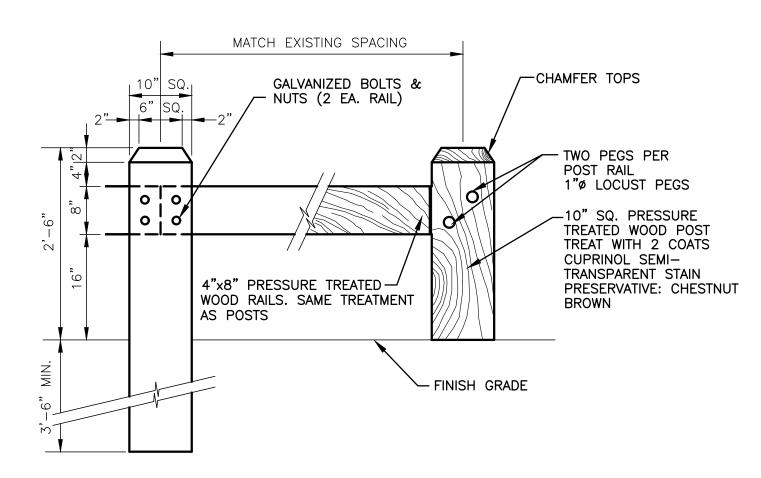



WOOD GUARDRAIL NOT TO SCALE

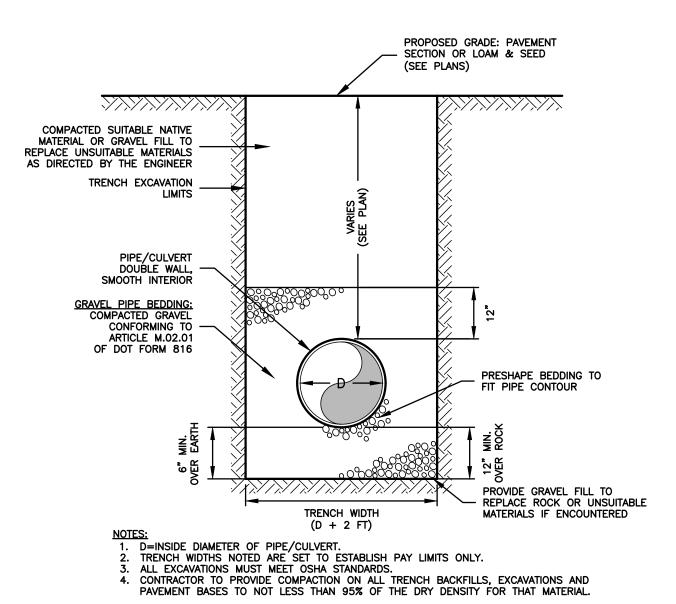

TRENCH DETAIL: DRAINAGE CULVERT NOT TO SCALE

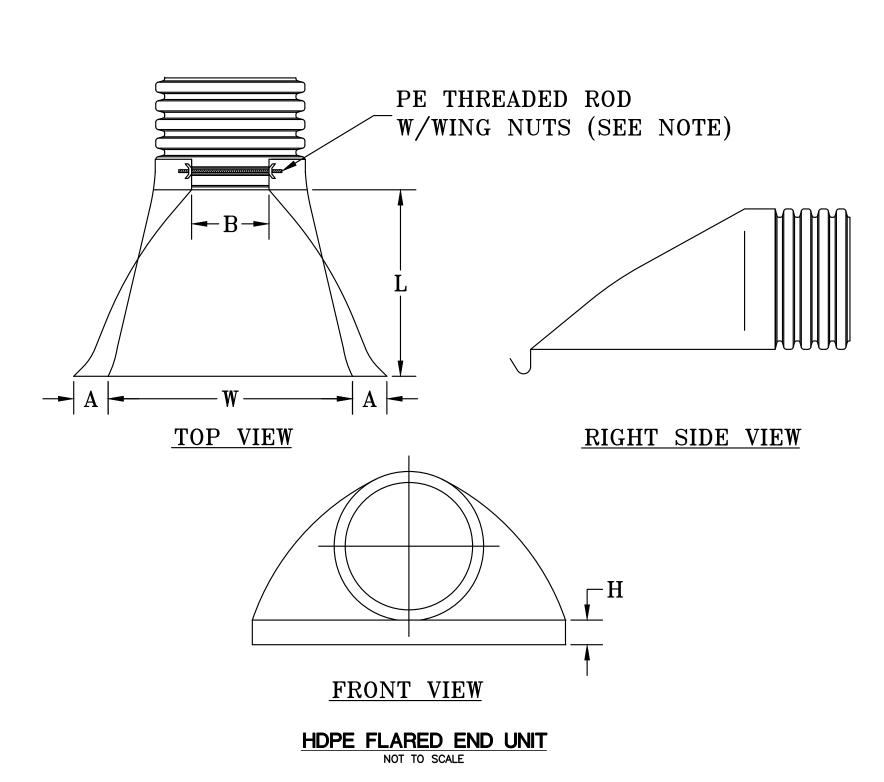

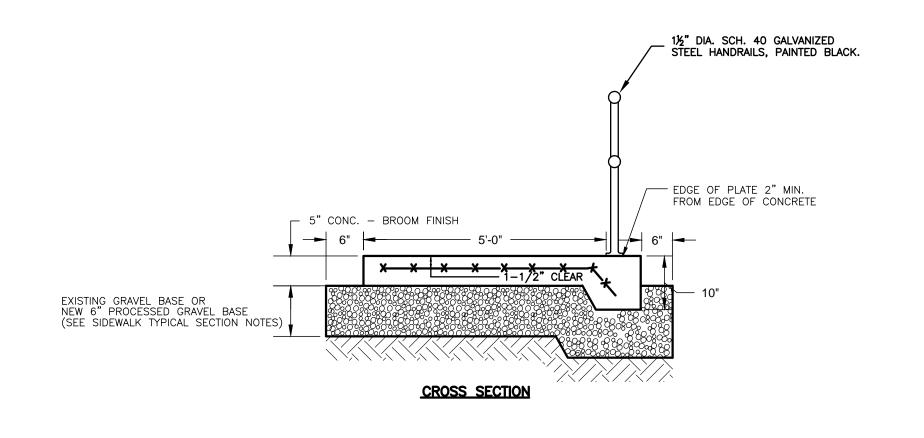

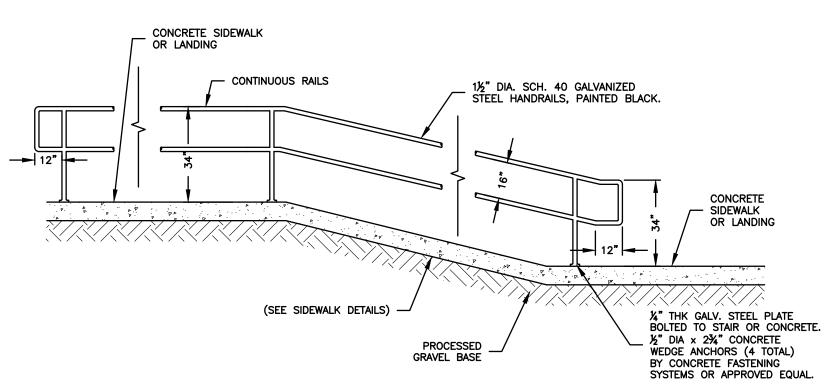

NOTES:

1. STAIR & HANDRAIL CONSTRUCTION SHALL BE IN CONFORMANCE WITH THE STATE OF CONNECTICUT BUILDING CODE.

2. SEE SITE PLAN FOR TOP & BOTTOM OF STAIR ELEVATIONS.

3. SEE SITE PLAN FOR STAIR WIDTH.

4. CONTRACTOR TO ADJUST EXACT TREAD DEPTH AND RISER HEIGHT TO MEET THE PROPOSED ELEVATIONS. ADJUSTMENTS MAY BE MADE ON THE FIELD TO MATCH EXISTING CONDITIONS.

5. THE GREATEST RISER HEIGHT WITHIN ANY FLIGHT OF STAIRS SHALL NOT EXCEED THE SMALL FST BY MORE THAN %"

SMALLEST BY MORE THAN %".
THE GREATEST TREAD DEPTH WITHIN ANY FLIGHT OF STAIRS SHALL NOT EXCEED THE

SMALLEST BY MORE THAN %".

7. HANDRAILS SHALL BE CONTINUOUS THROUGH INTERMEDIATE LANDINGS.

8. HANDRAIL TURNS SHALL BE RADIUSED AT 2" MIN. ALL CONNECTIONS TO BE WELDED AND

GROUND SMOOTH 9. HANDRAILS SHALL BE 1½" DIAMETER SCH. 40 GALVANIZED STEEL.

10. HANDRAILS SHALL BE PRIMED AND PAINTED — BLACK. PAINT SHALL BE APPLIED PER THE MANUFACTURERS RECOMMENDATIONS
PRIMER: 1 COAT SHERWIN WILLIAMS KEM BOND HS UNIVERSAL METAL PRIMER, B50Z SERIES © 3.0-5.0 MILS DFTOR APPROVED EQUAL
FINISH: 2 COATS SHERWIN WILLIAMS HI—SOLIDS POLYURETHANE B65—300 © 3.0-4.0

DFT/CT OR APPROVED EQUAL

CONCRETE SIDEWALK WITH HANDRAIL DETAIL

NOT TO SCALE

