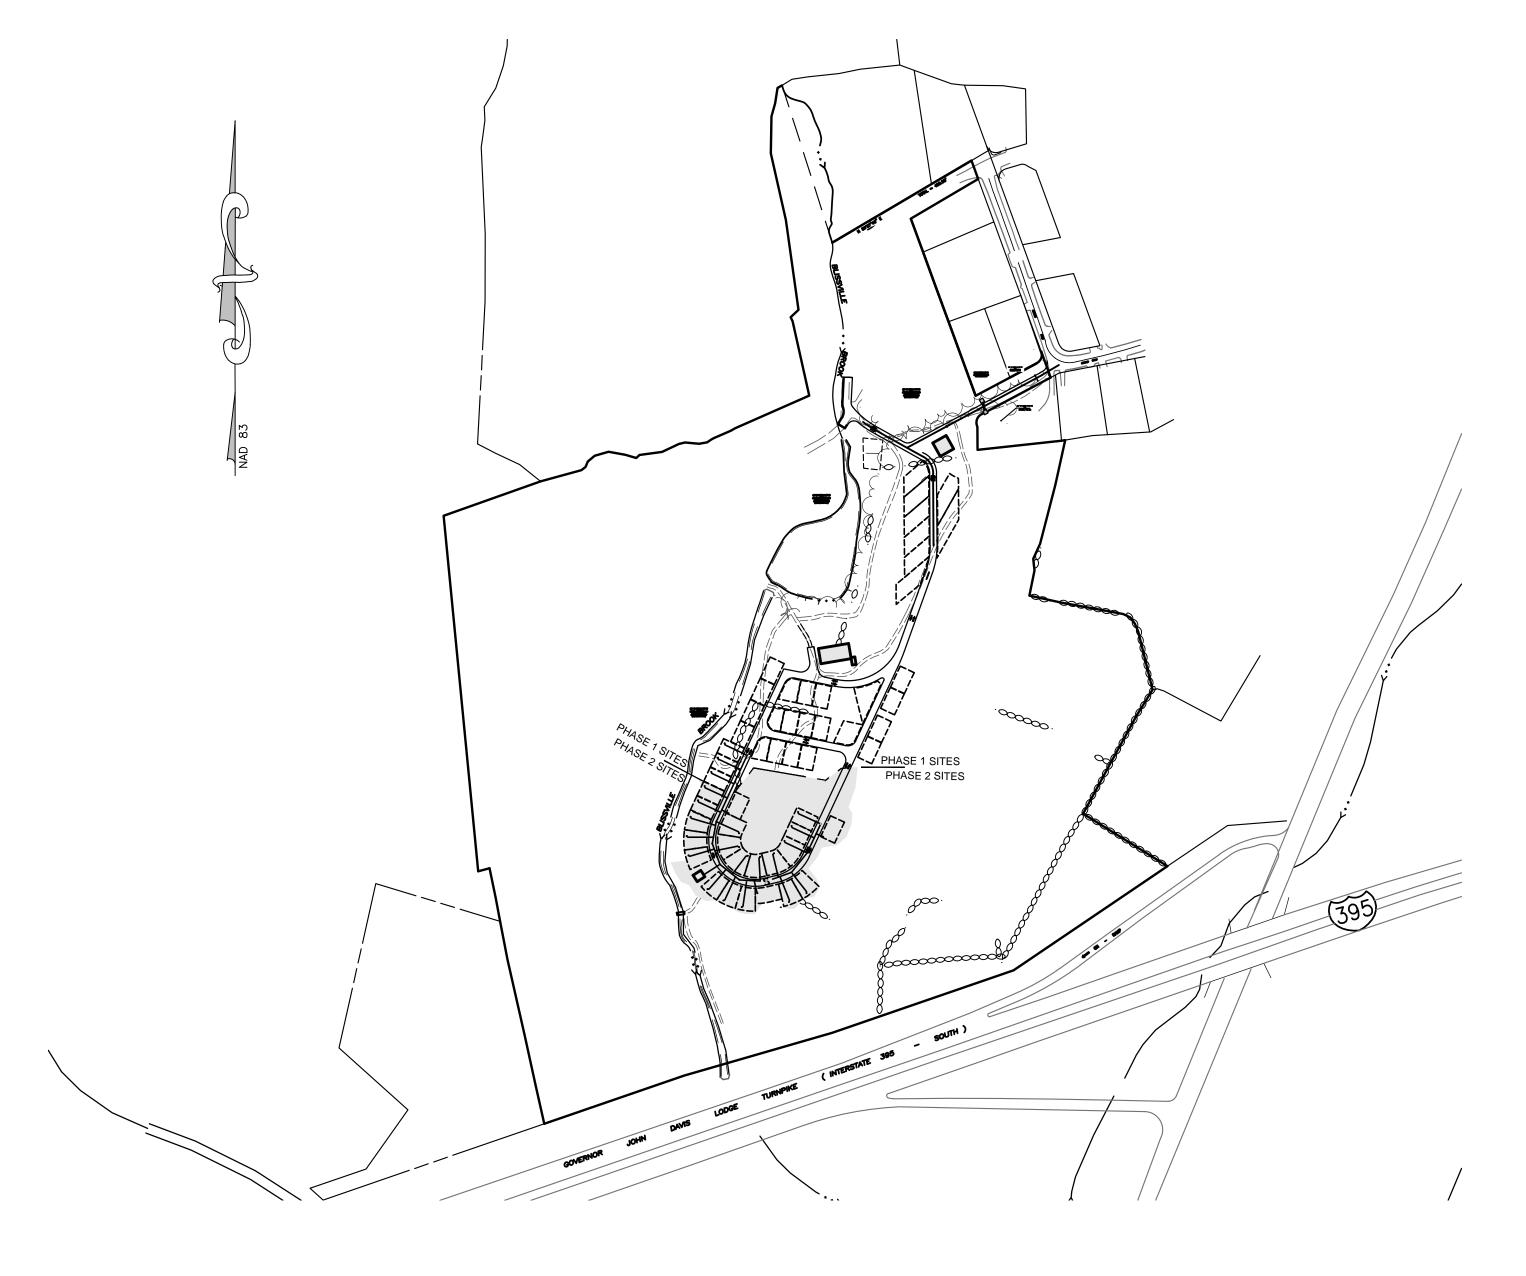
SITE DEVELOPMENT PLAN

PREPARED FOR

SUNFOX CAMPGROUND, LLC

15 KENYON ROAD LISBON, CONNECTICUT NOVEMBER 20, 2020

CIVIL DRAWING INDEX		
SHEET NUMBER	SHEET TITLE	
1	COVER SHEET	
2	EXISTING CONDITIONS 1 OF 2	
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PROPERTY OWNER: SUNFOX CAMPGROUND, LLC 15 KENYON ROAD

LISBON, CONNECTICUT 06351


APPLICANT: SUNFOX CAMPGROUND, LLC 15 KENYON ROAD LISBON, CONNECTICUT 0635


ZONING DISTRICT: R-60


EXISTING USE: CAMPGROUND


PROPOSED USES: CAMPGROUND




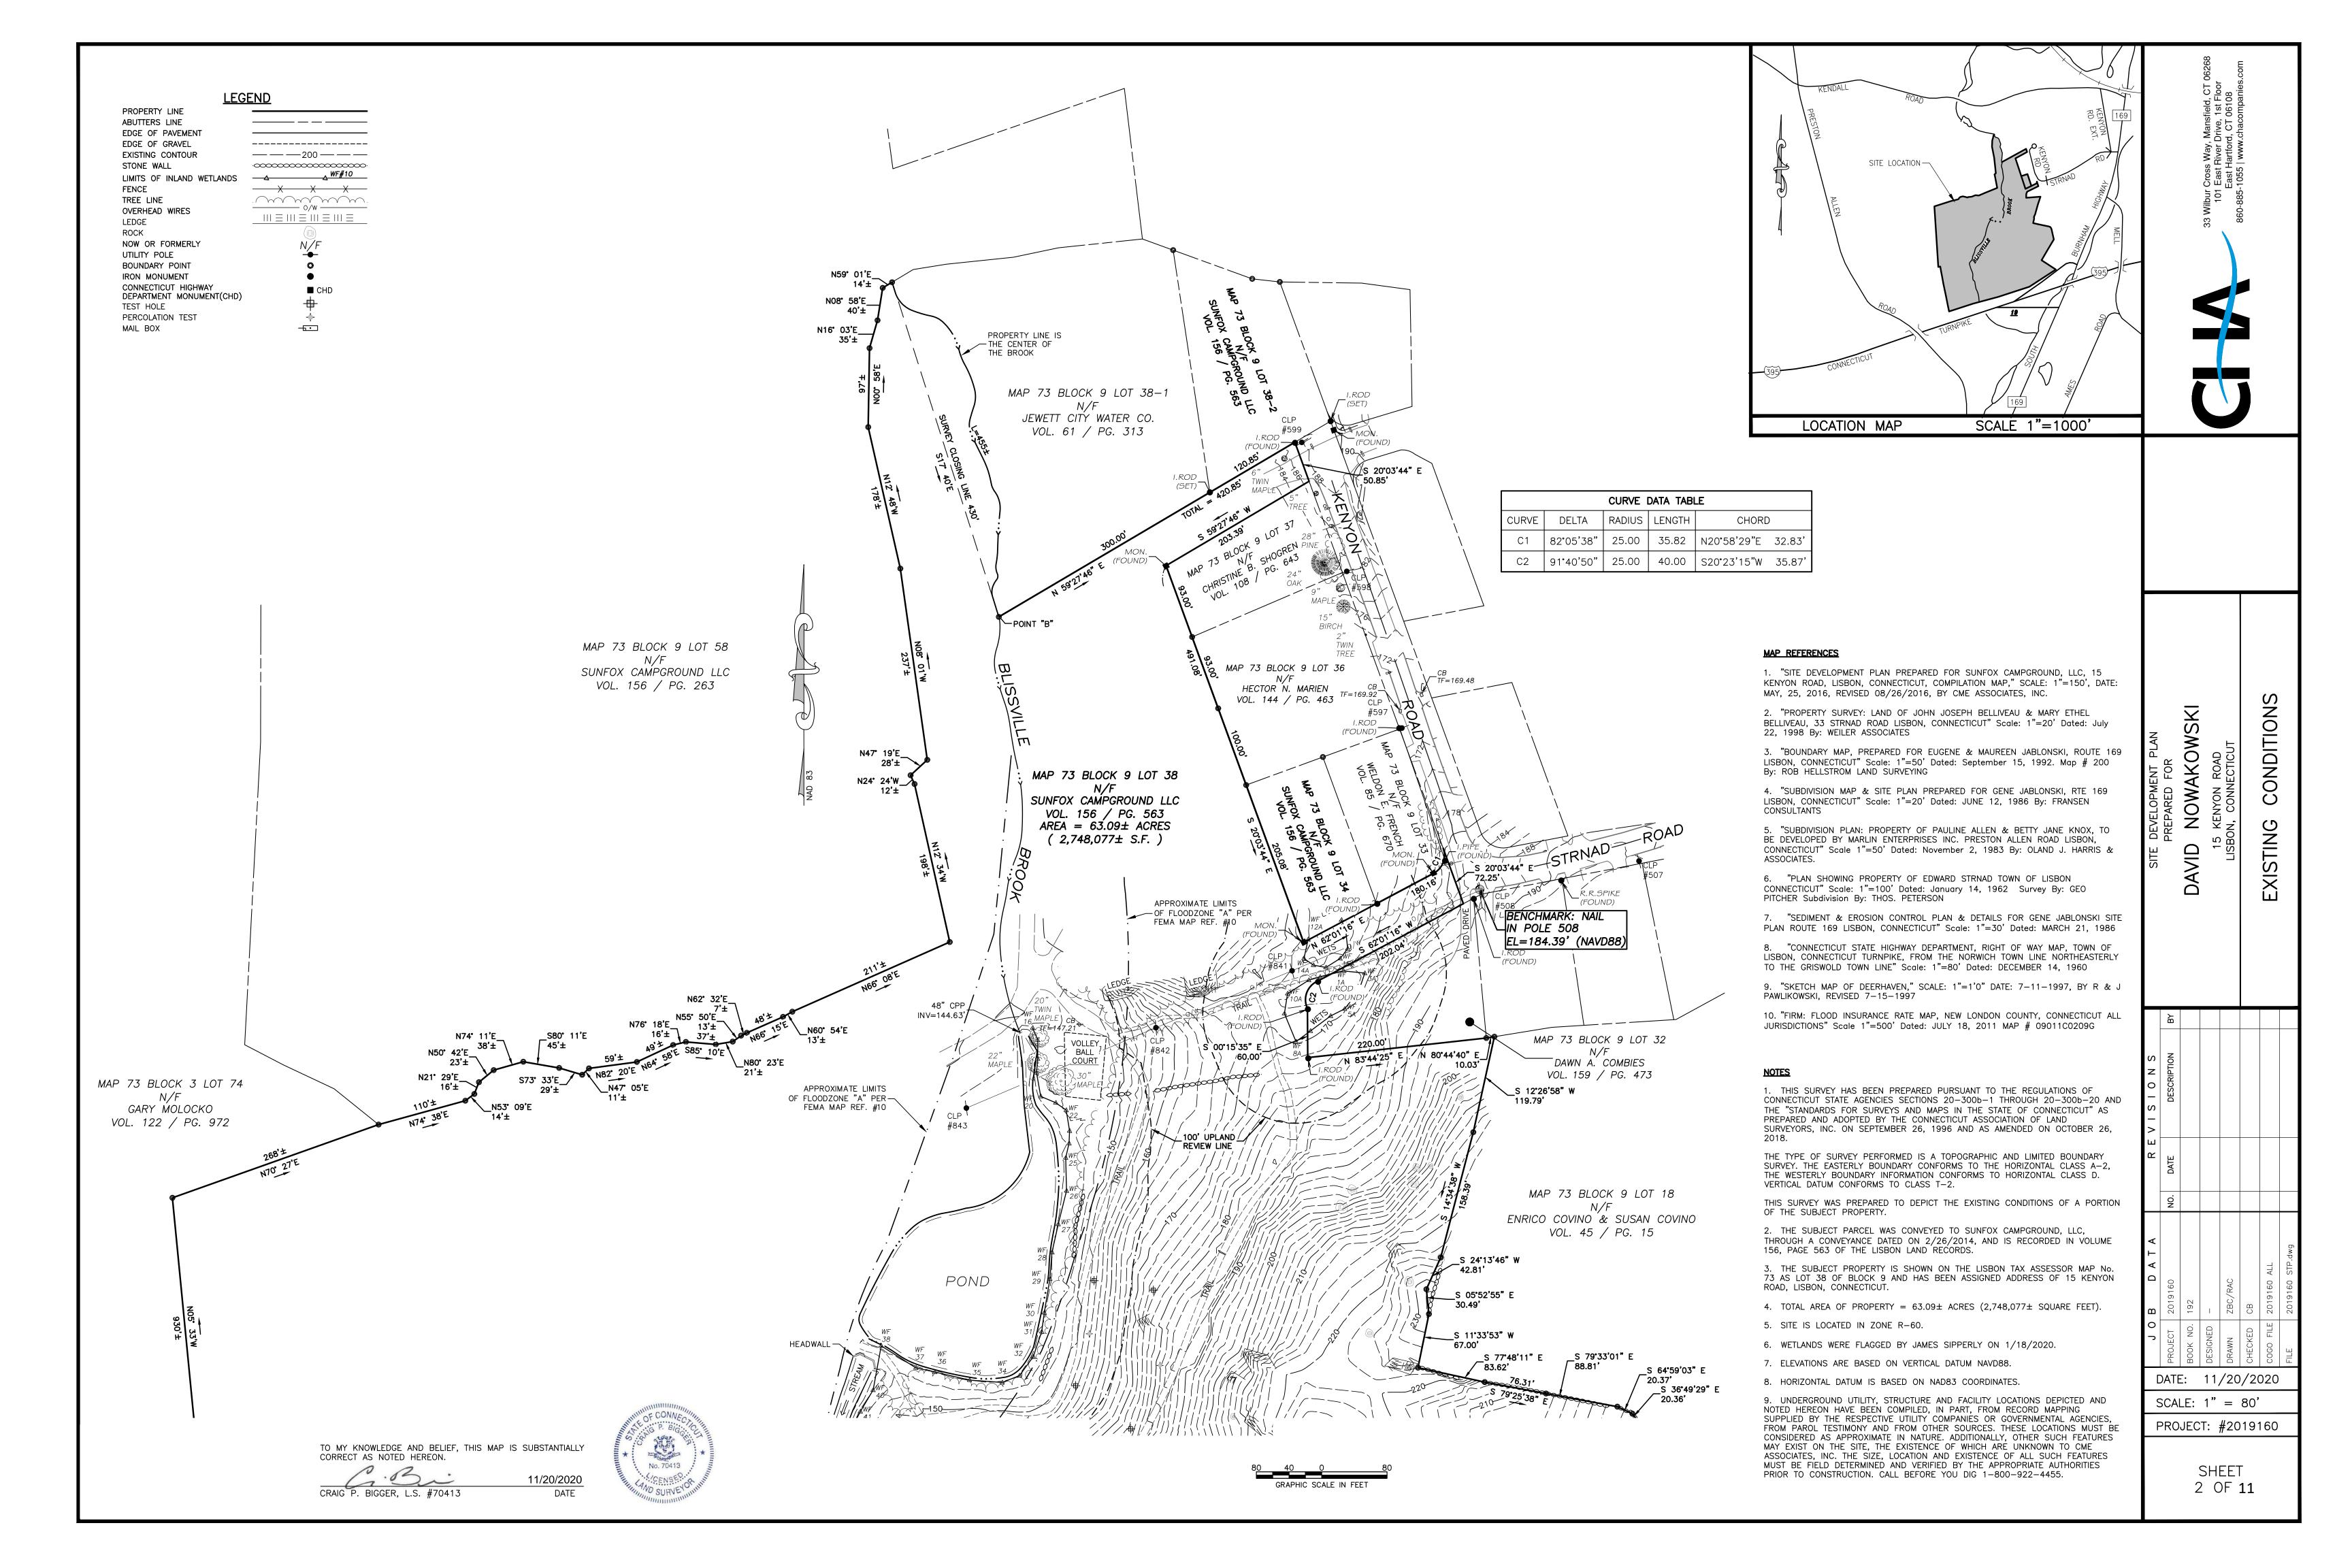


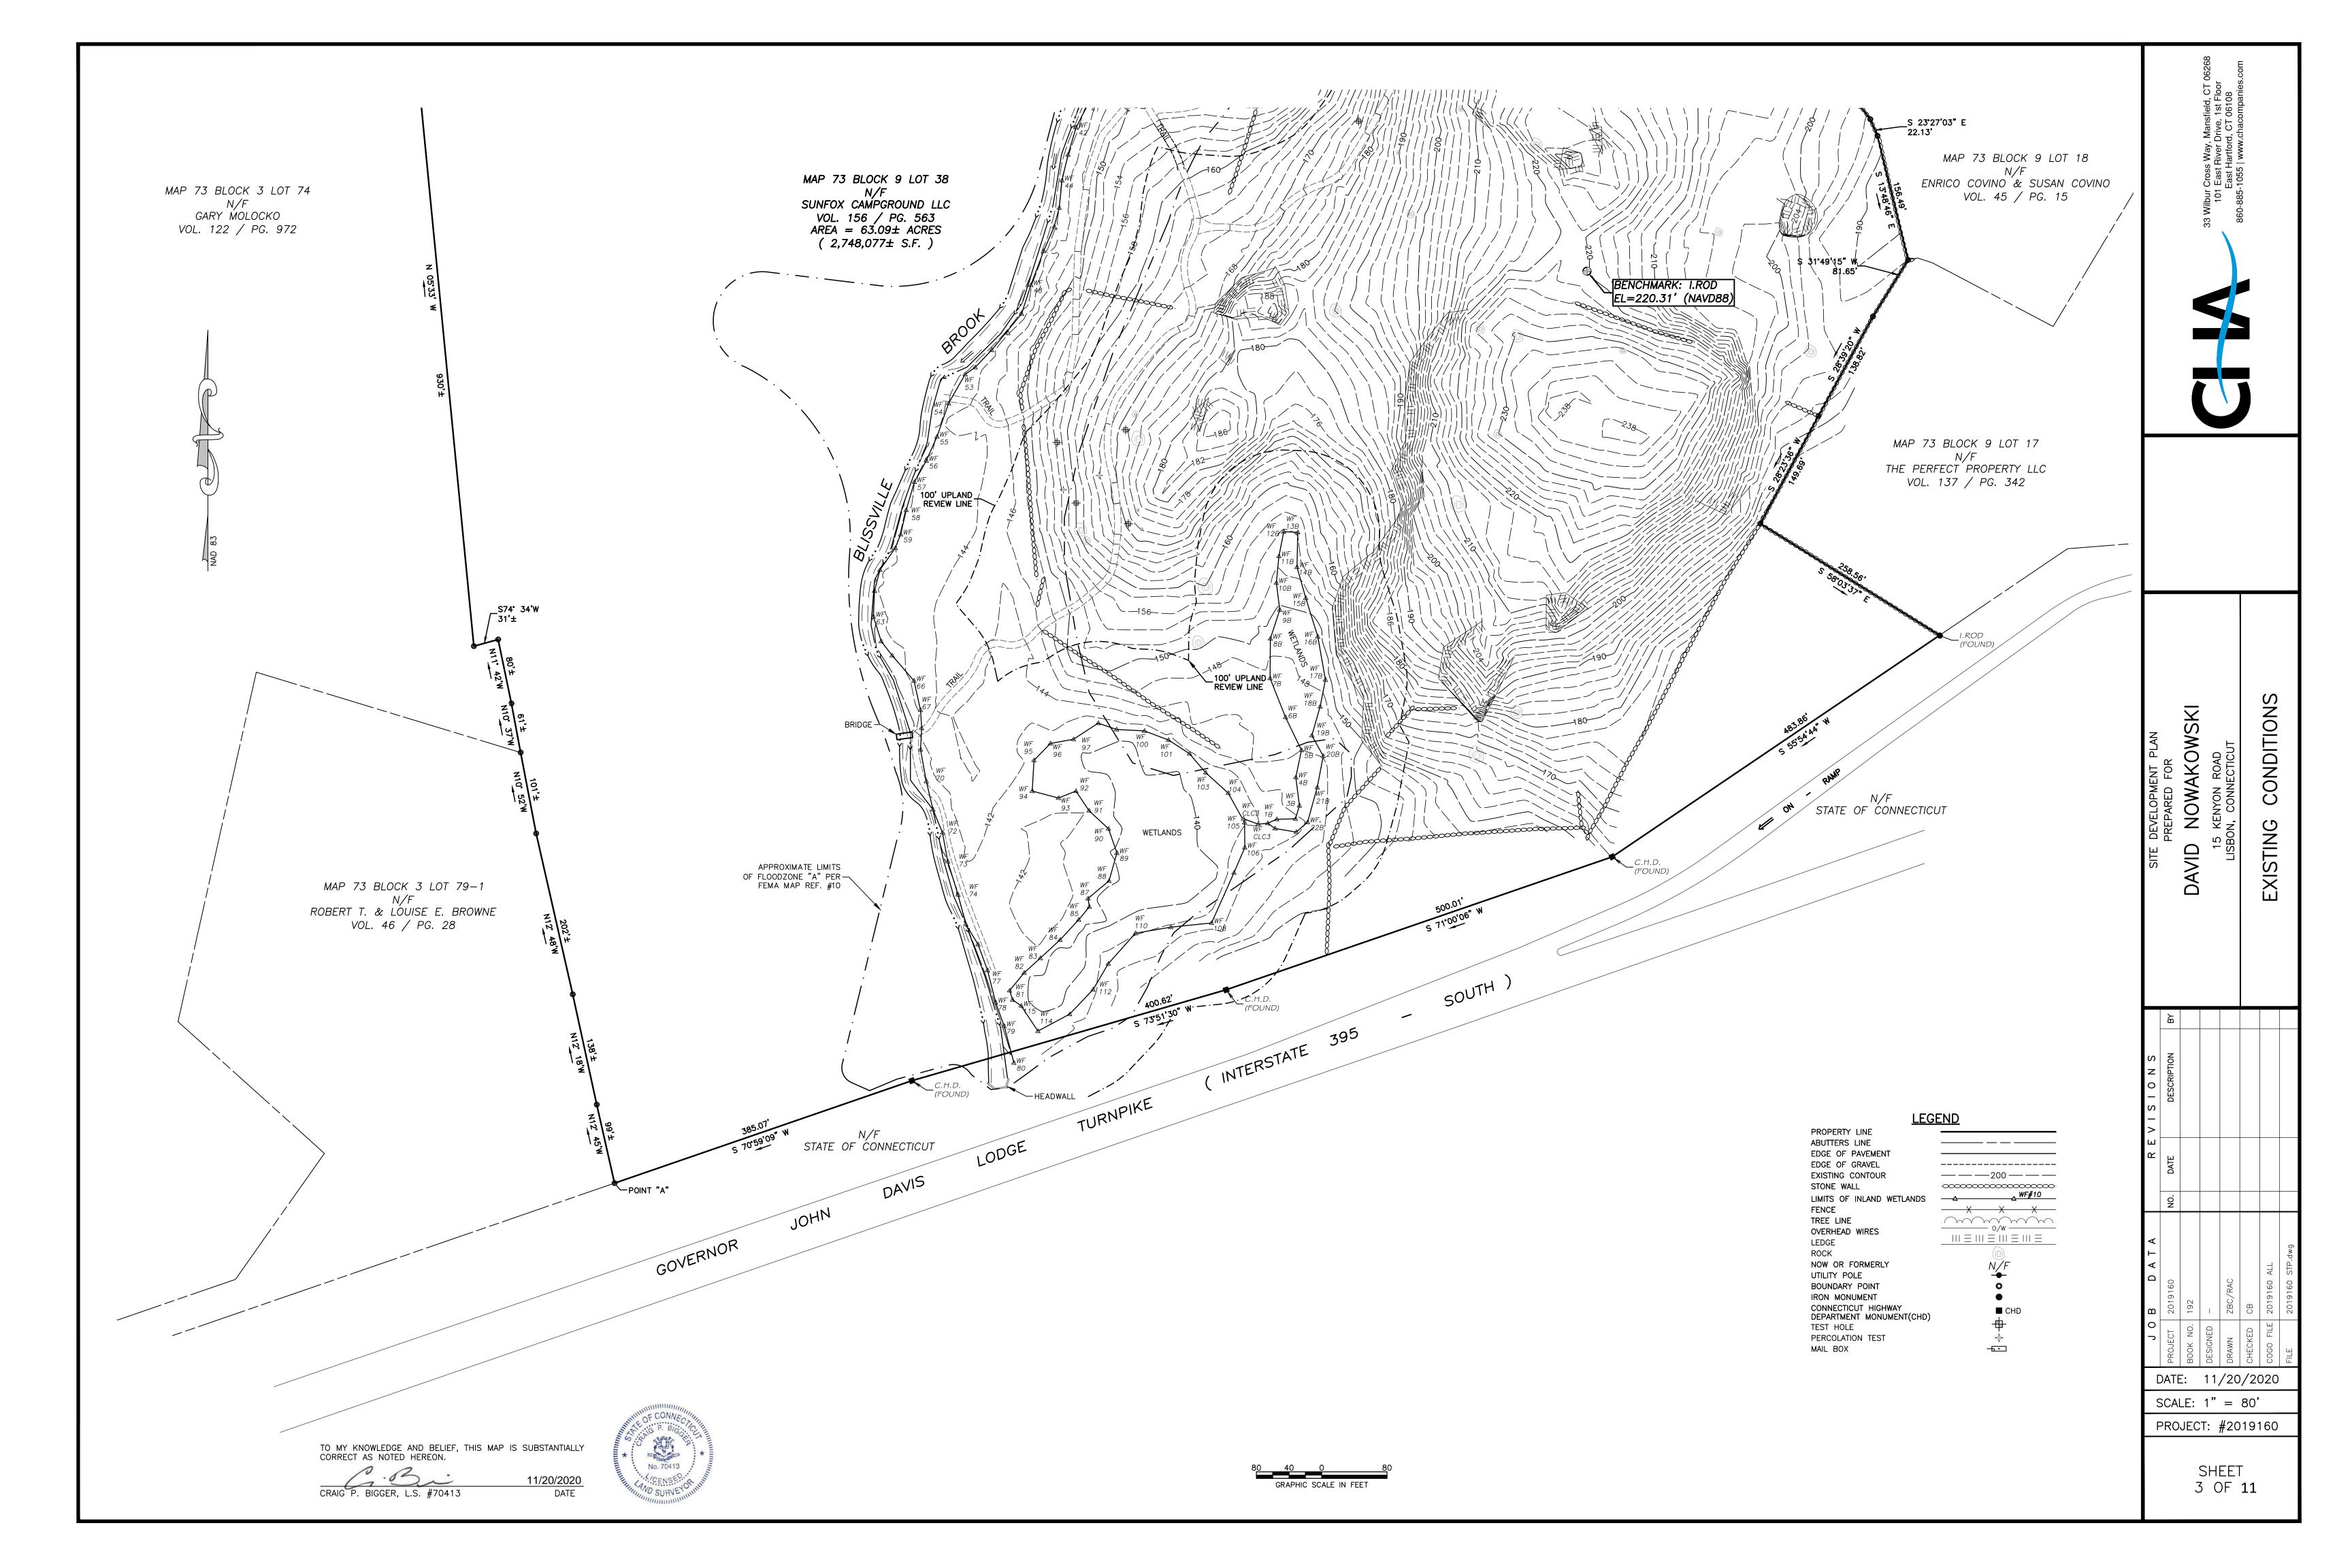


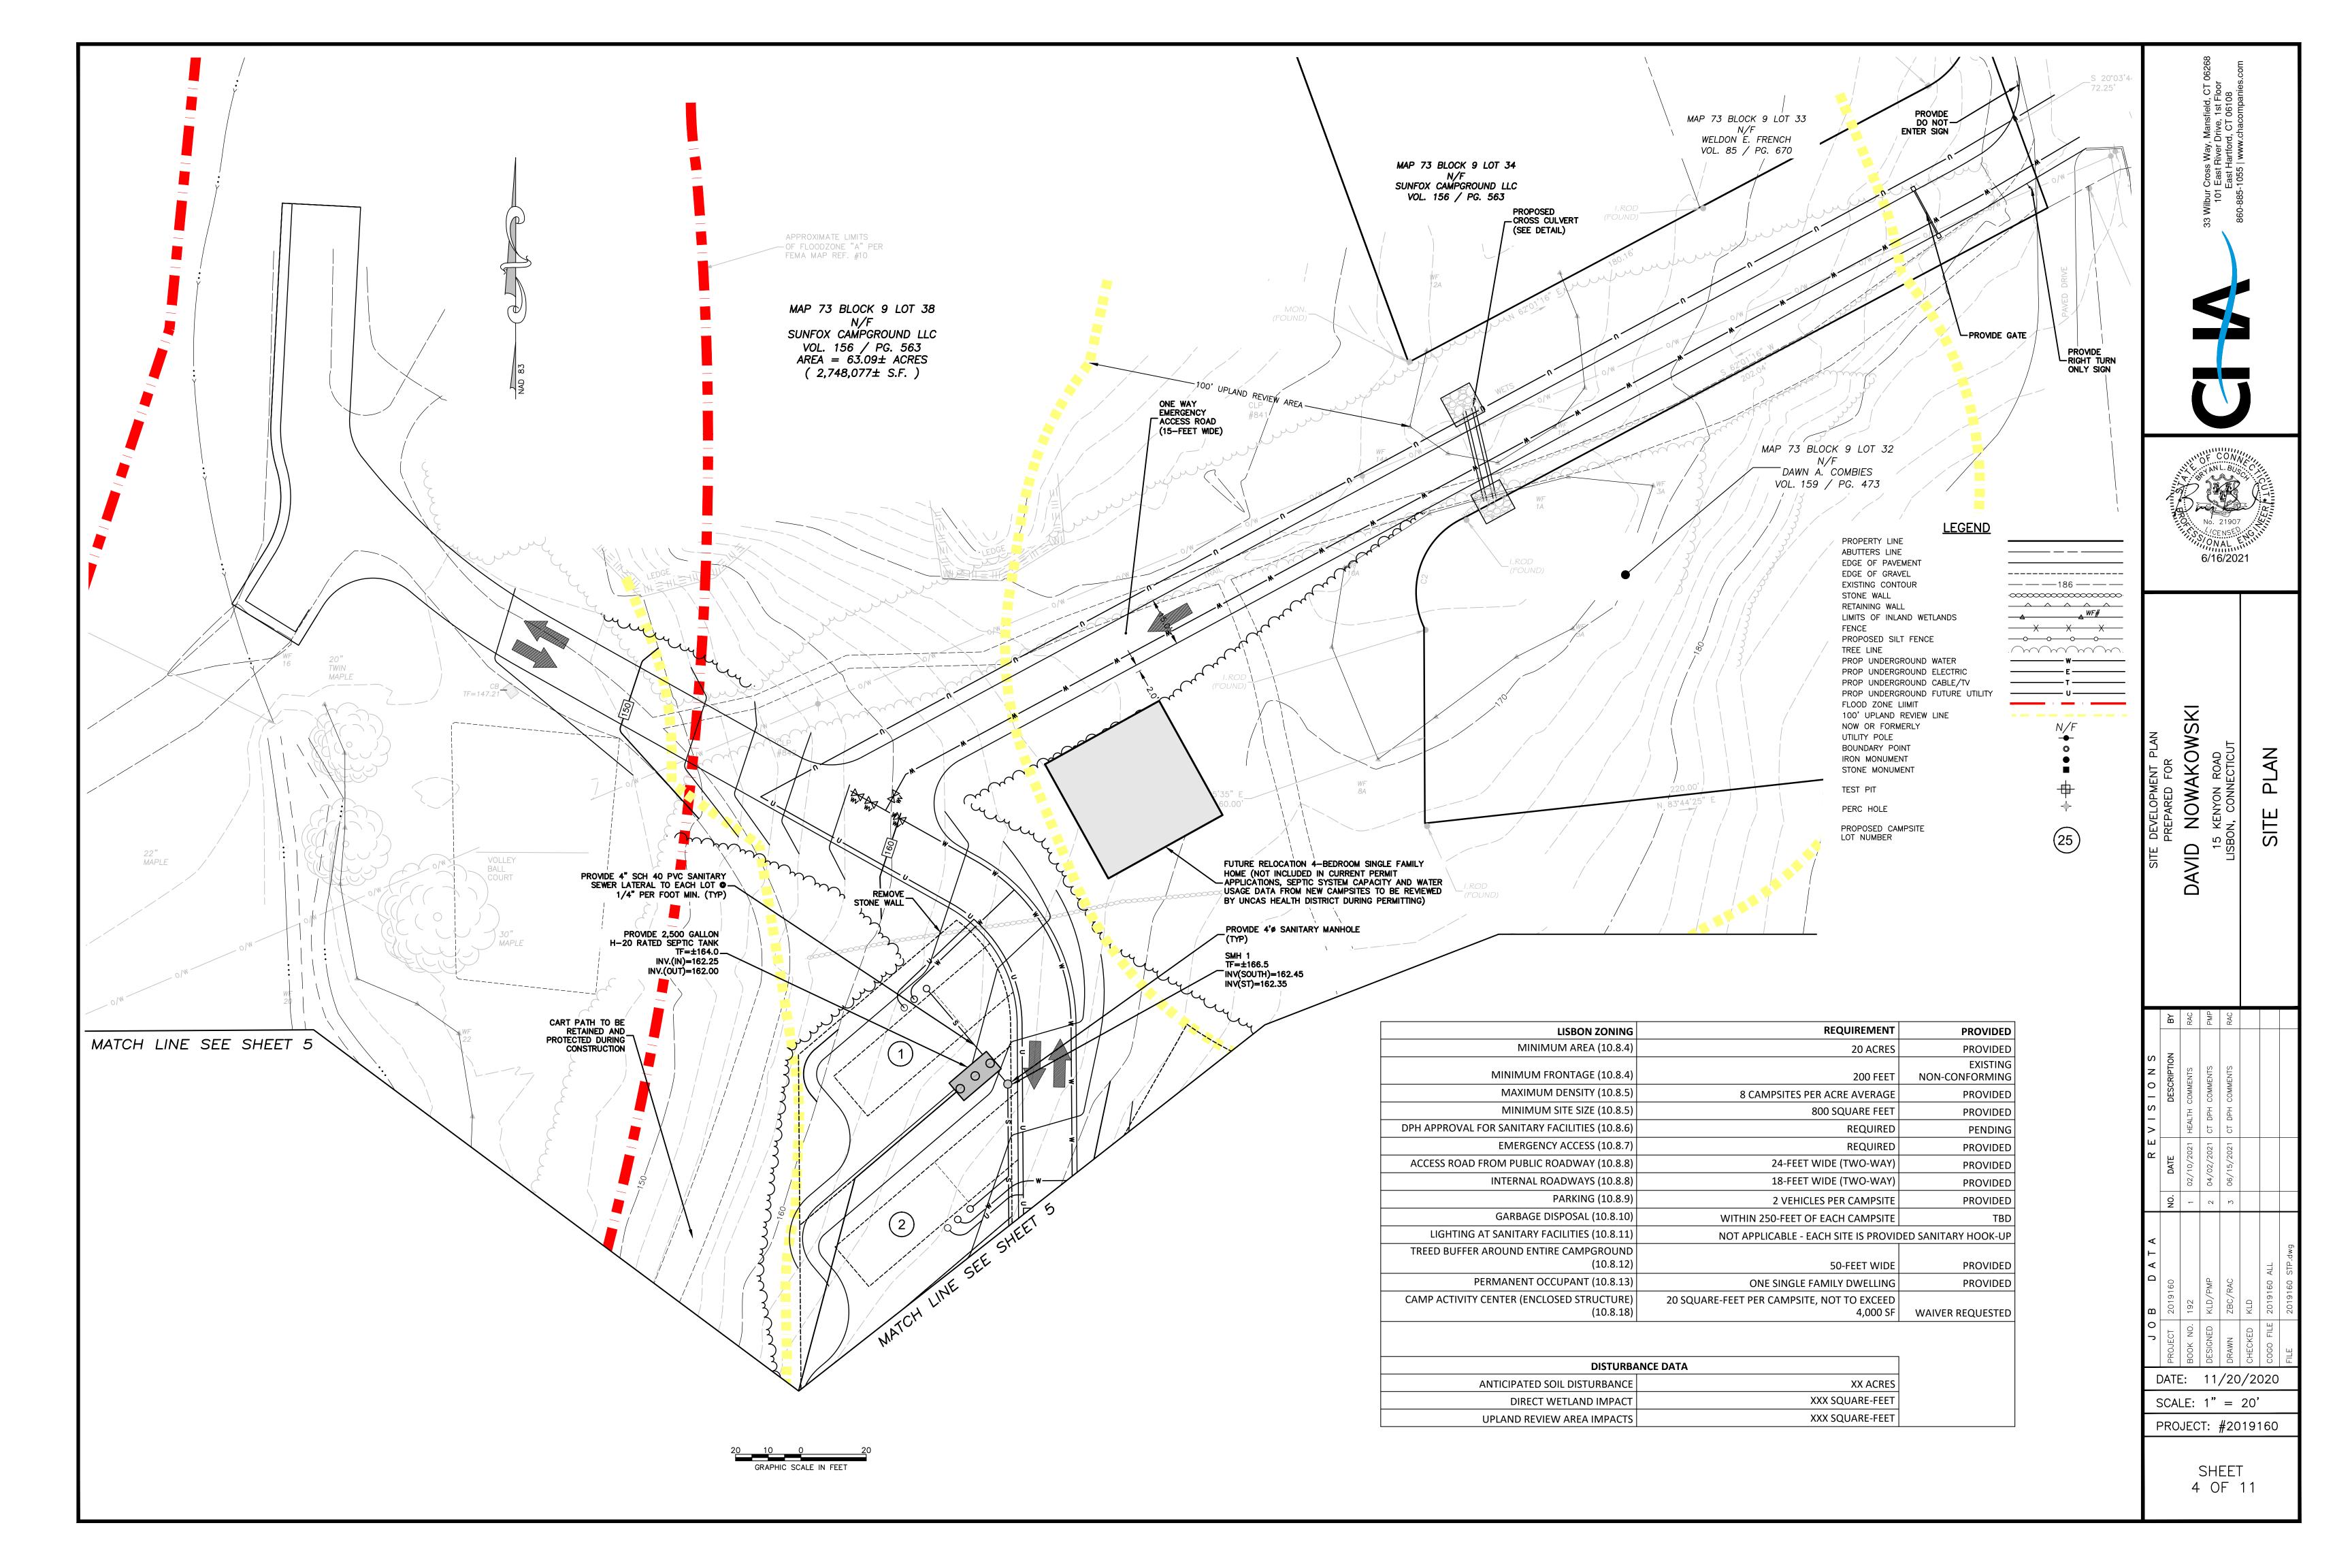


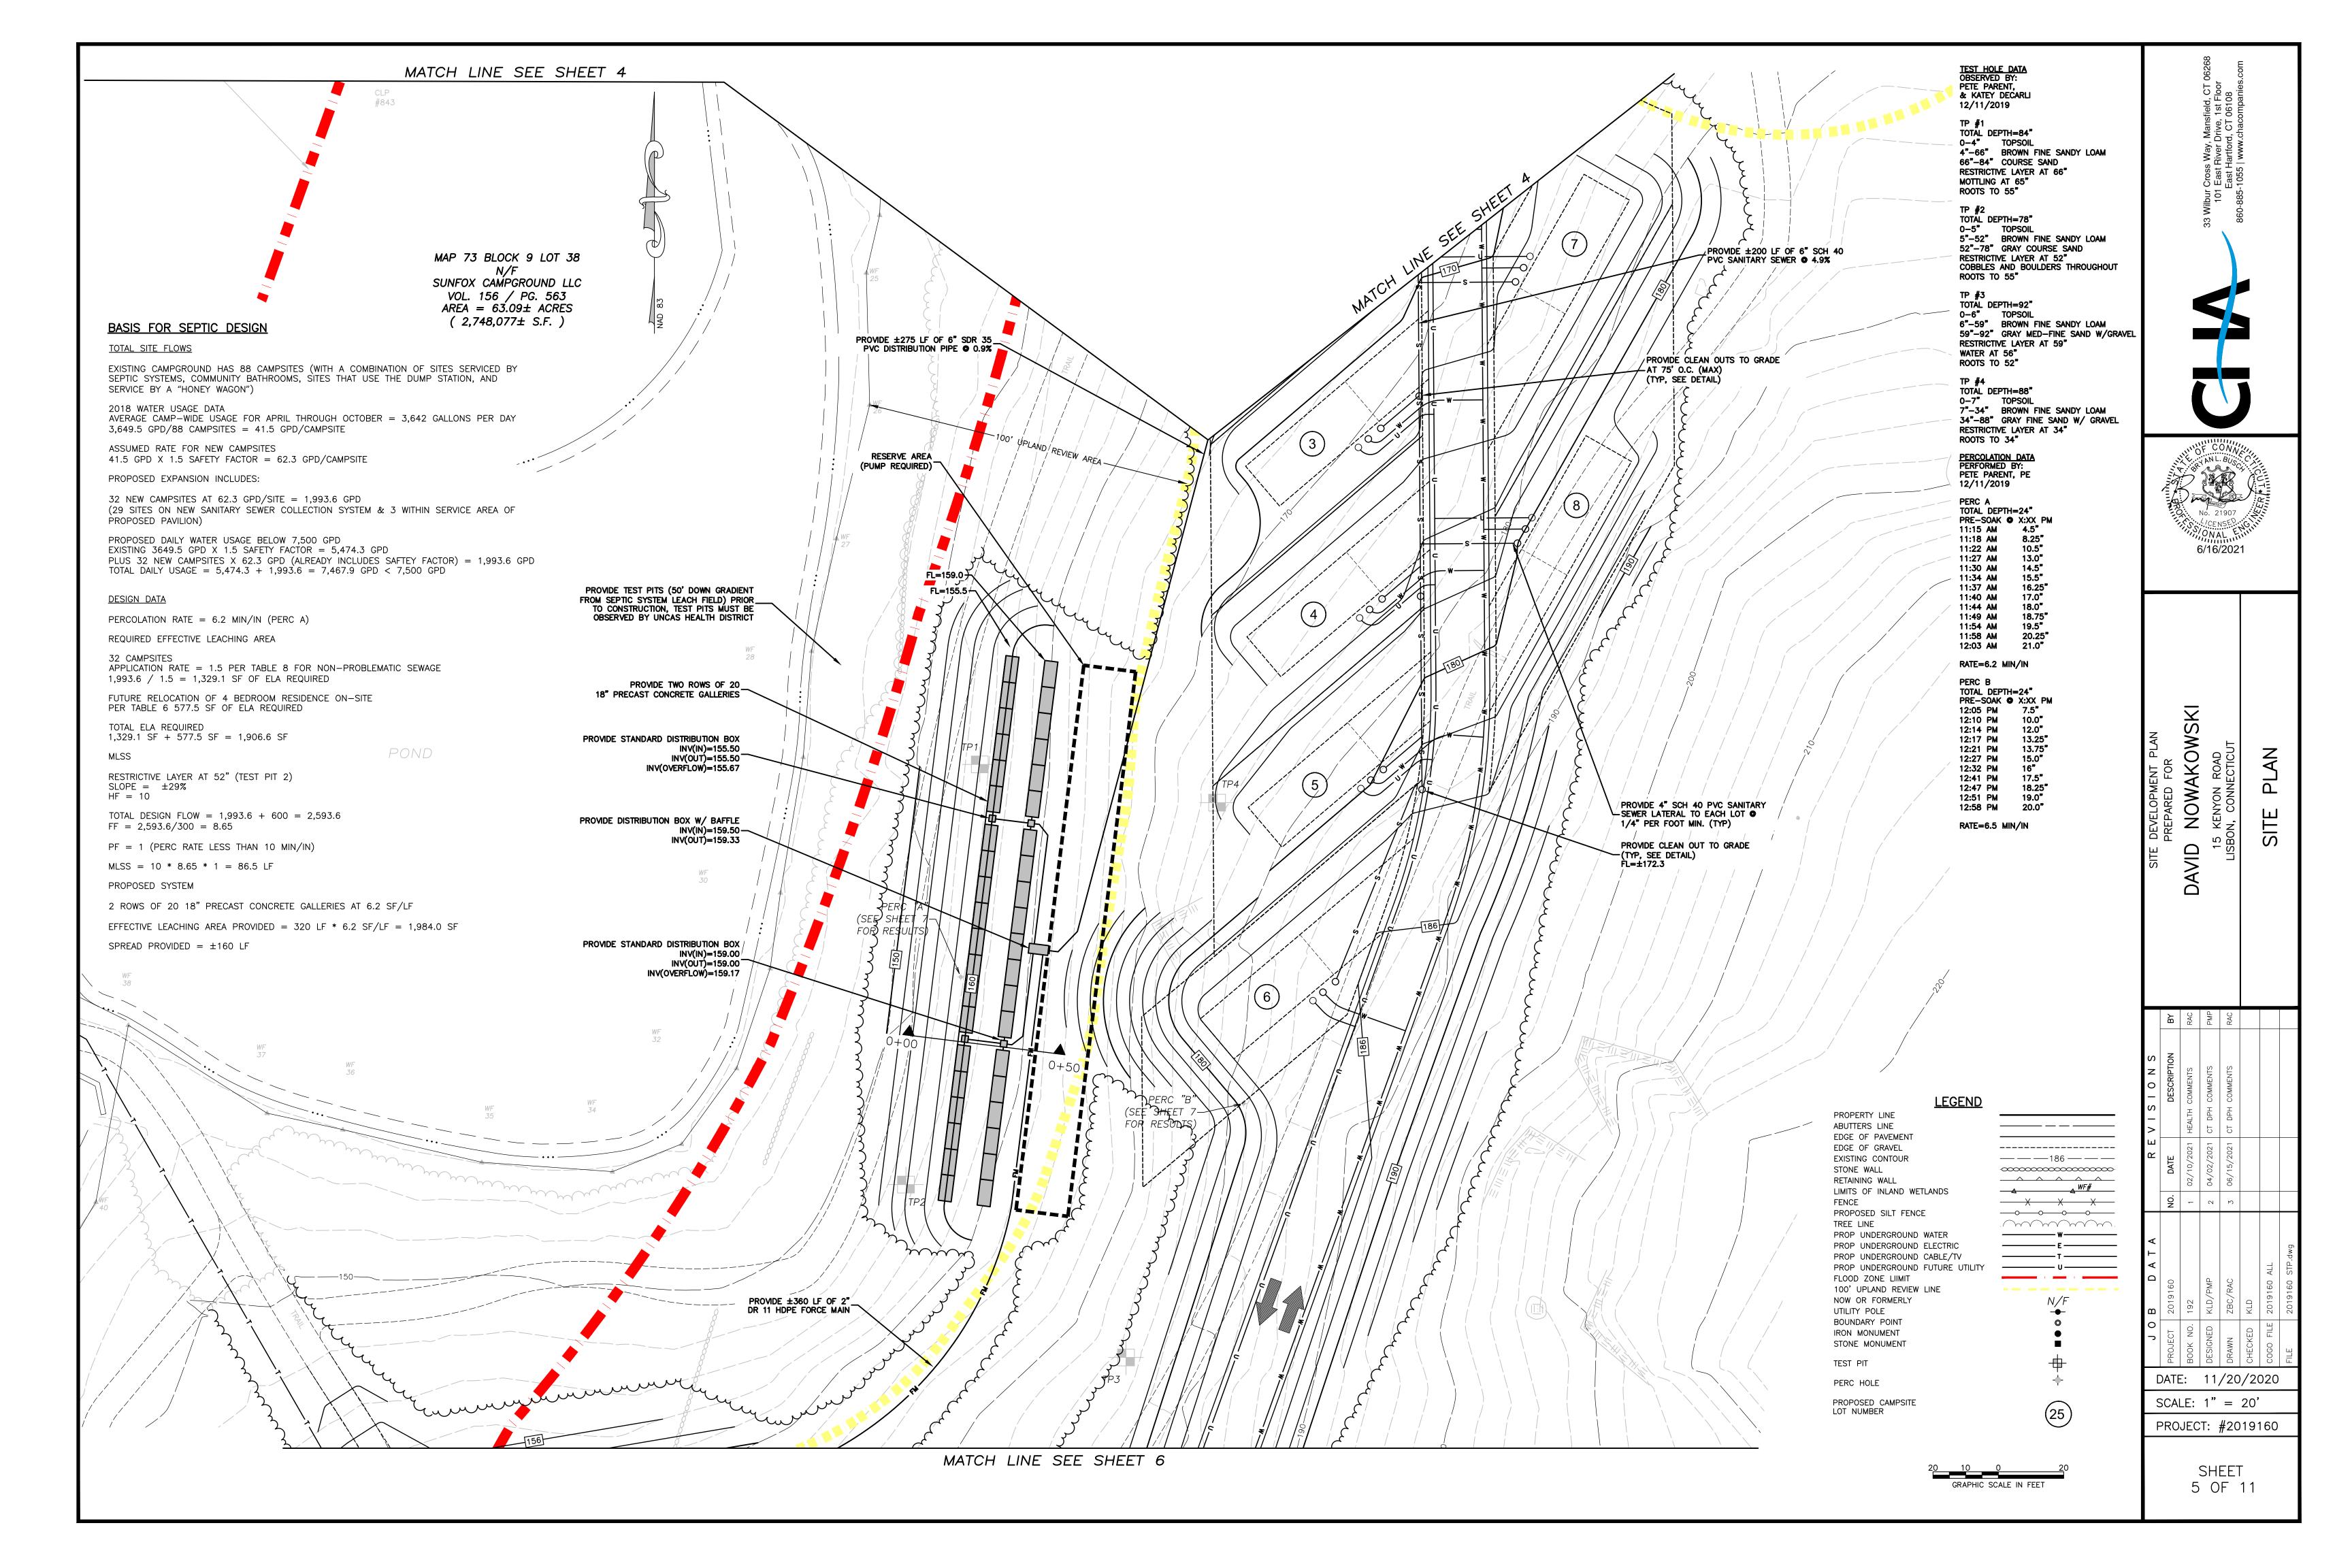

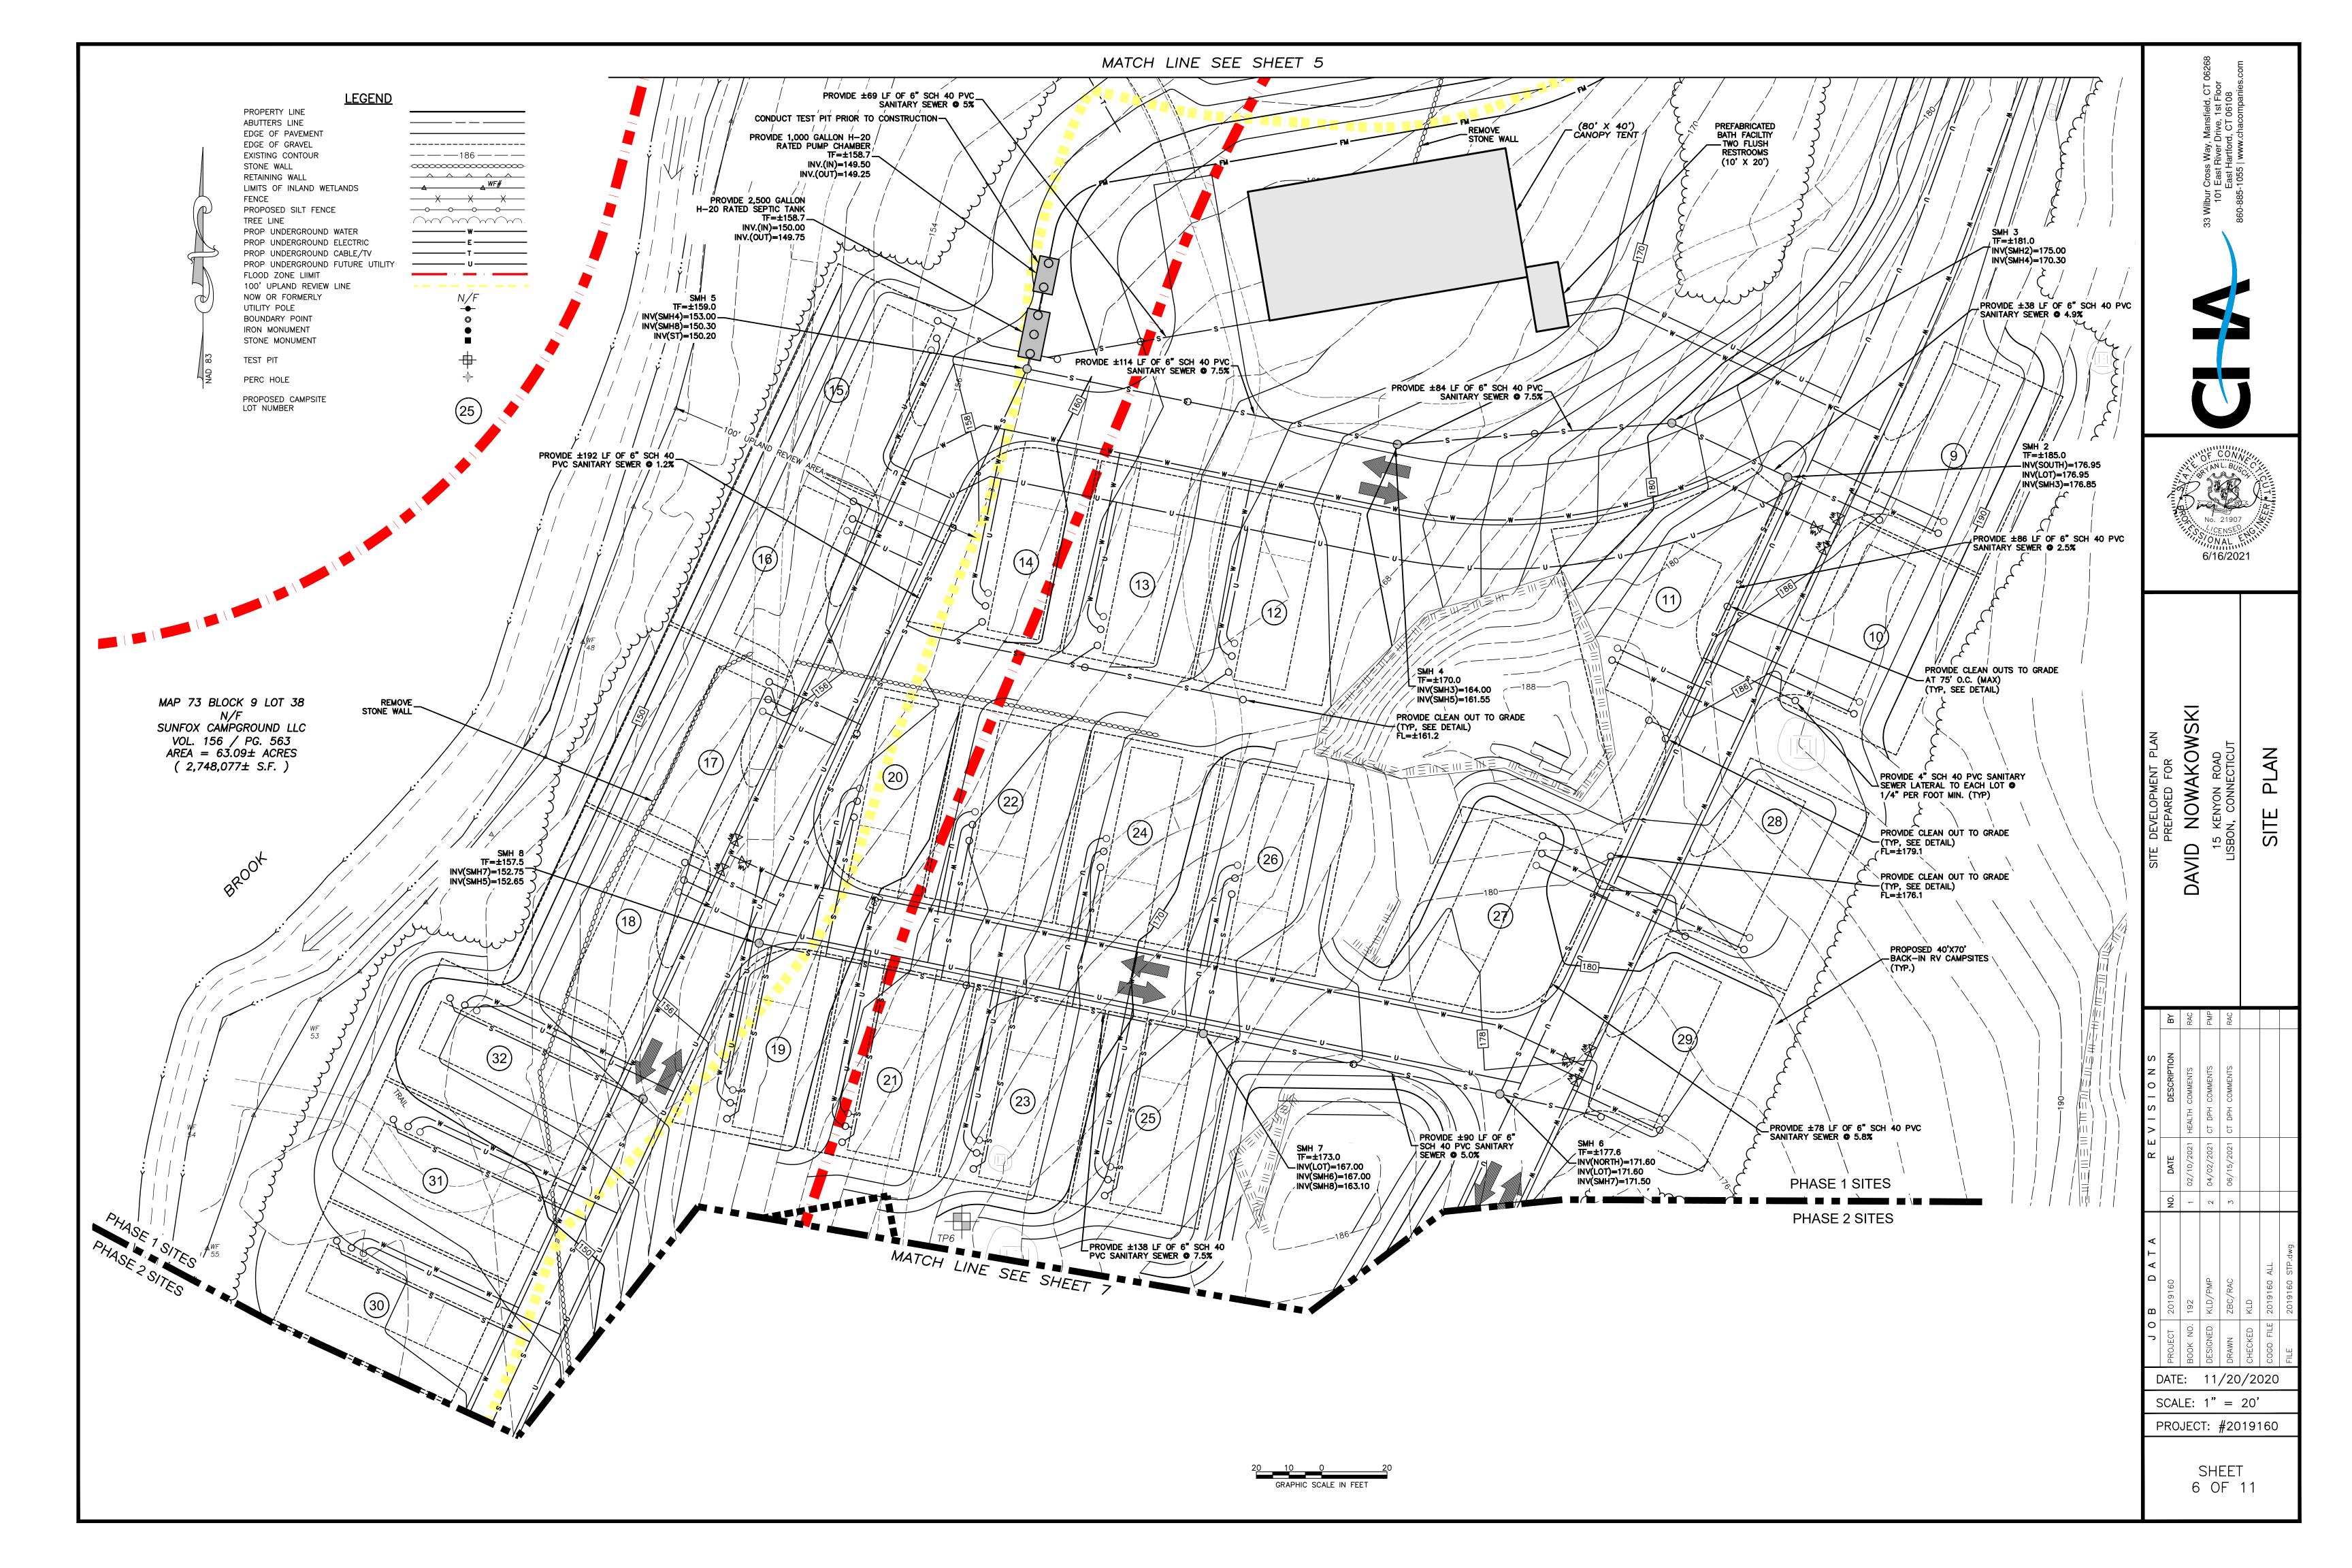

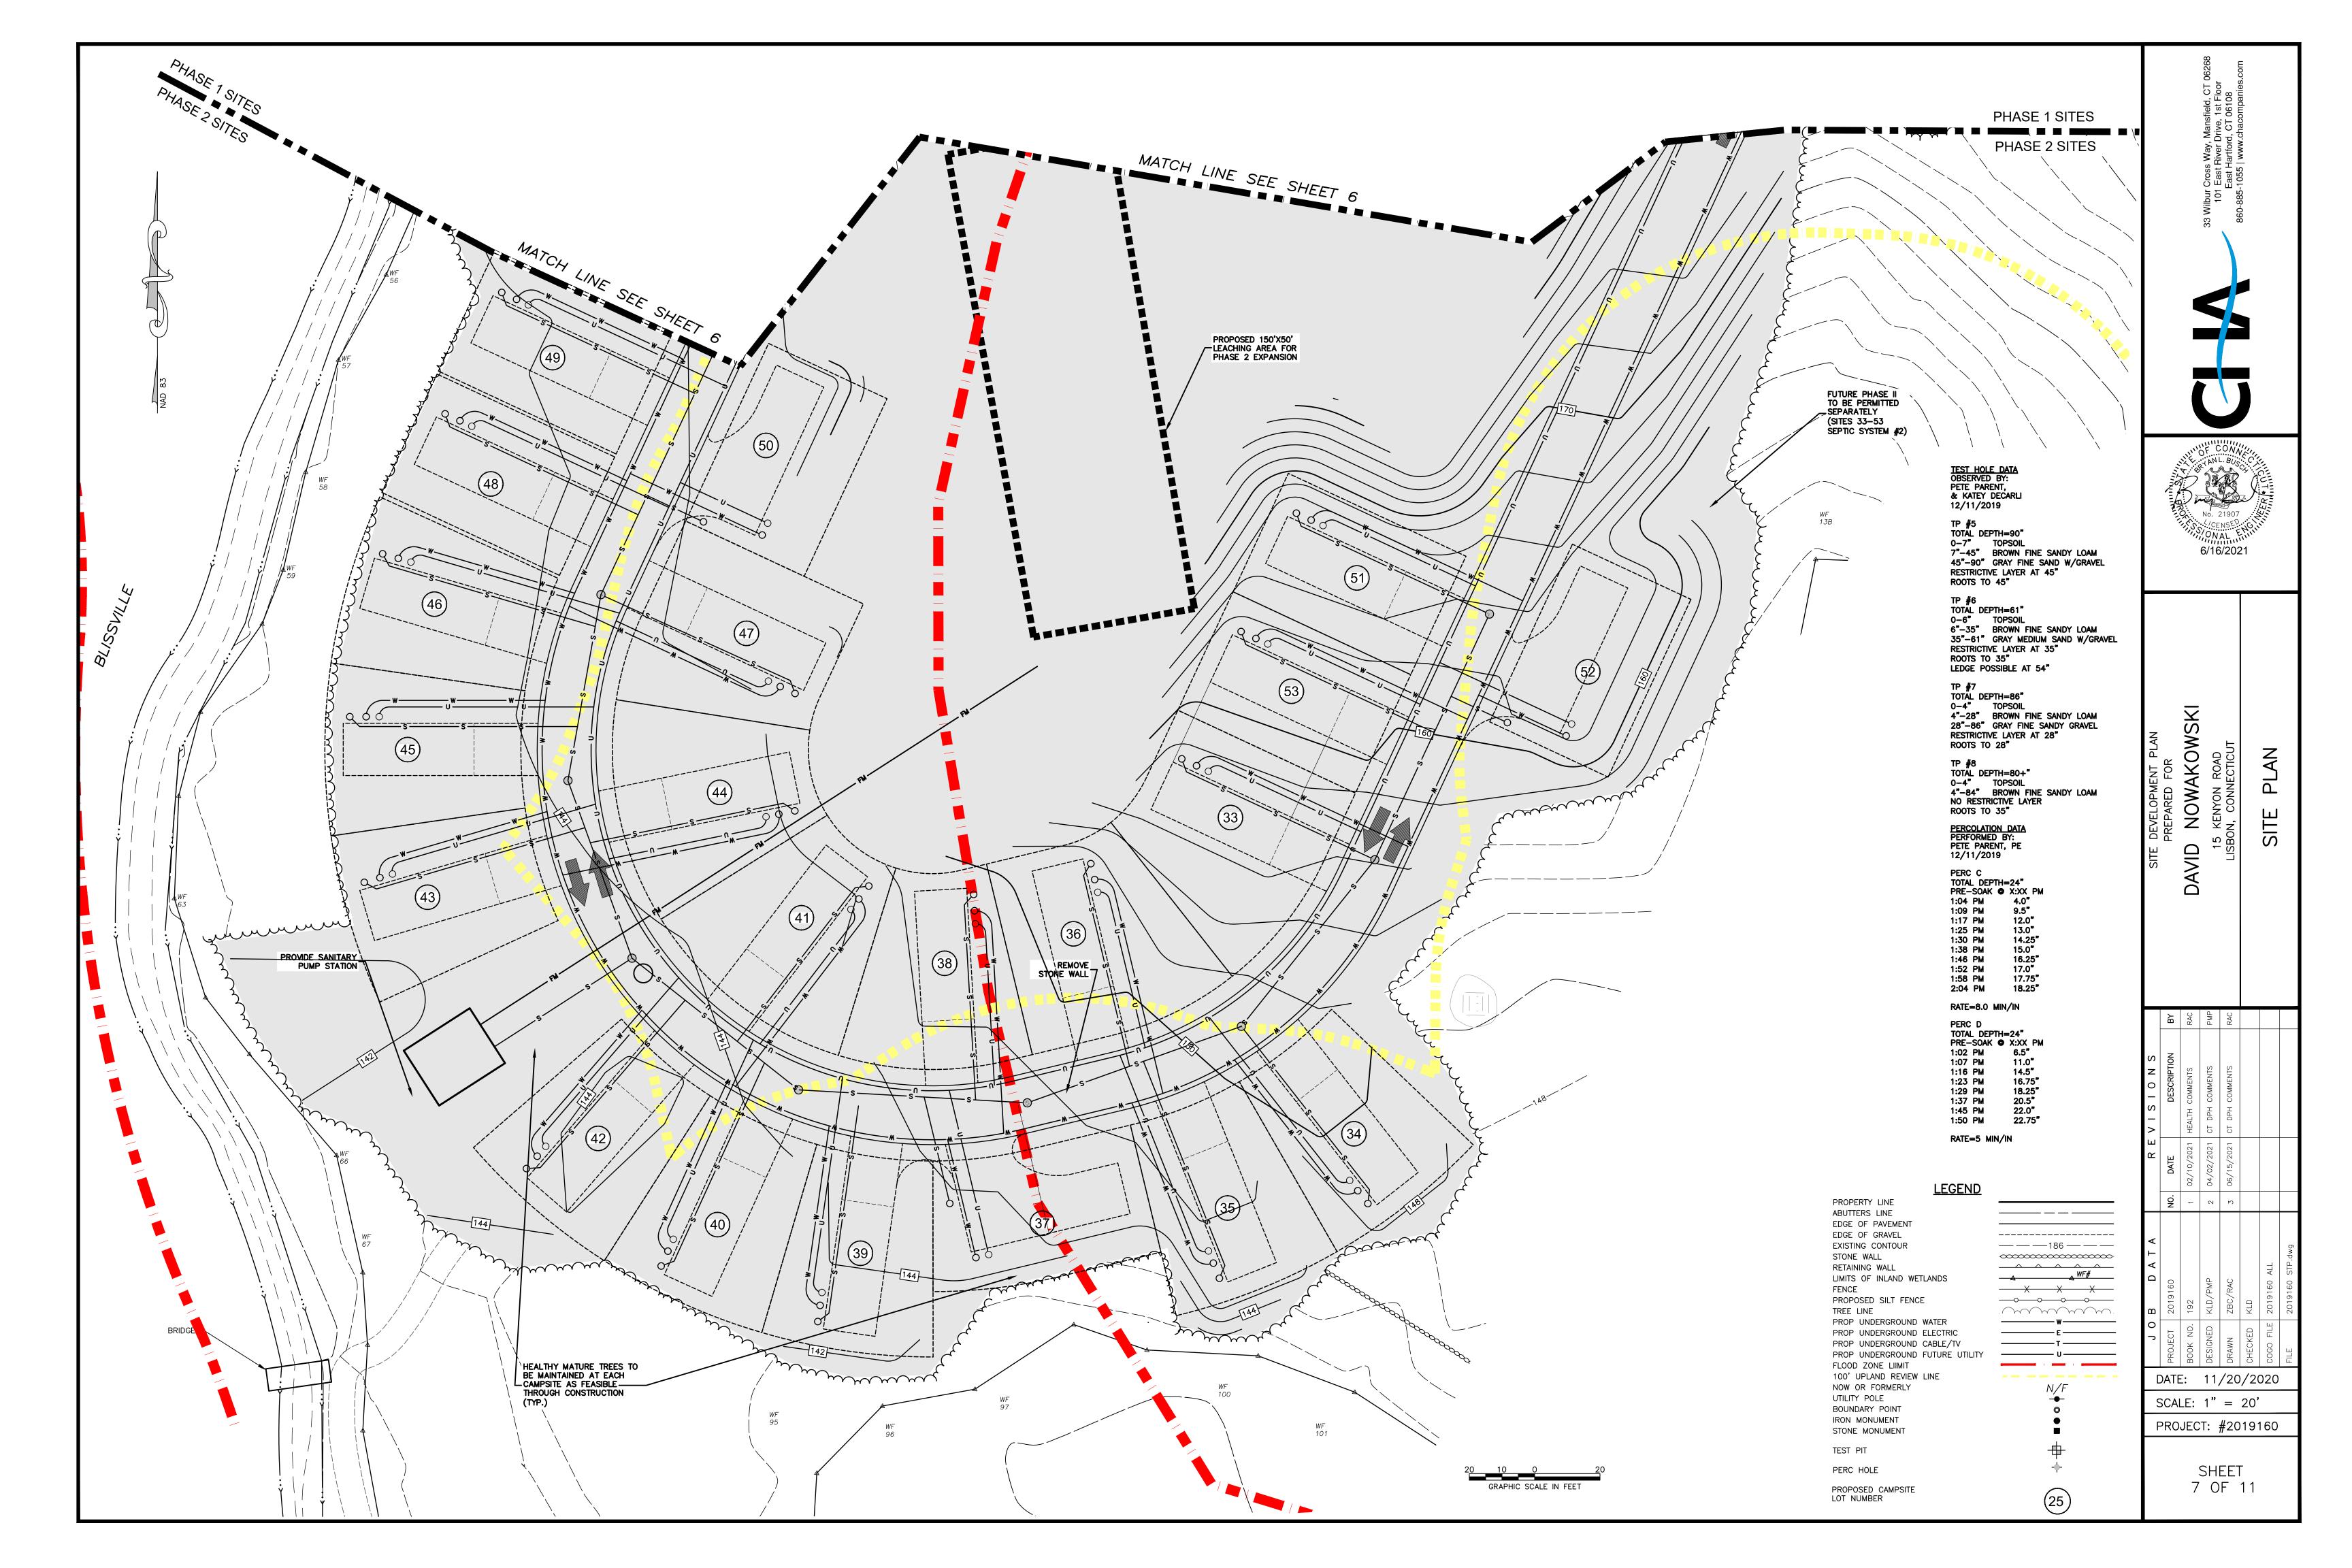

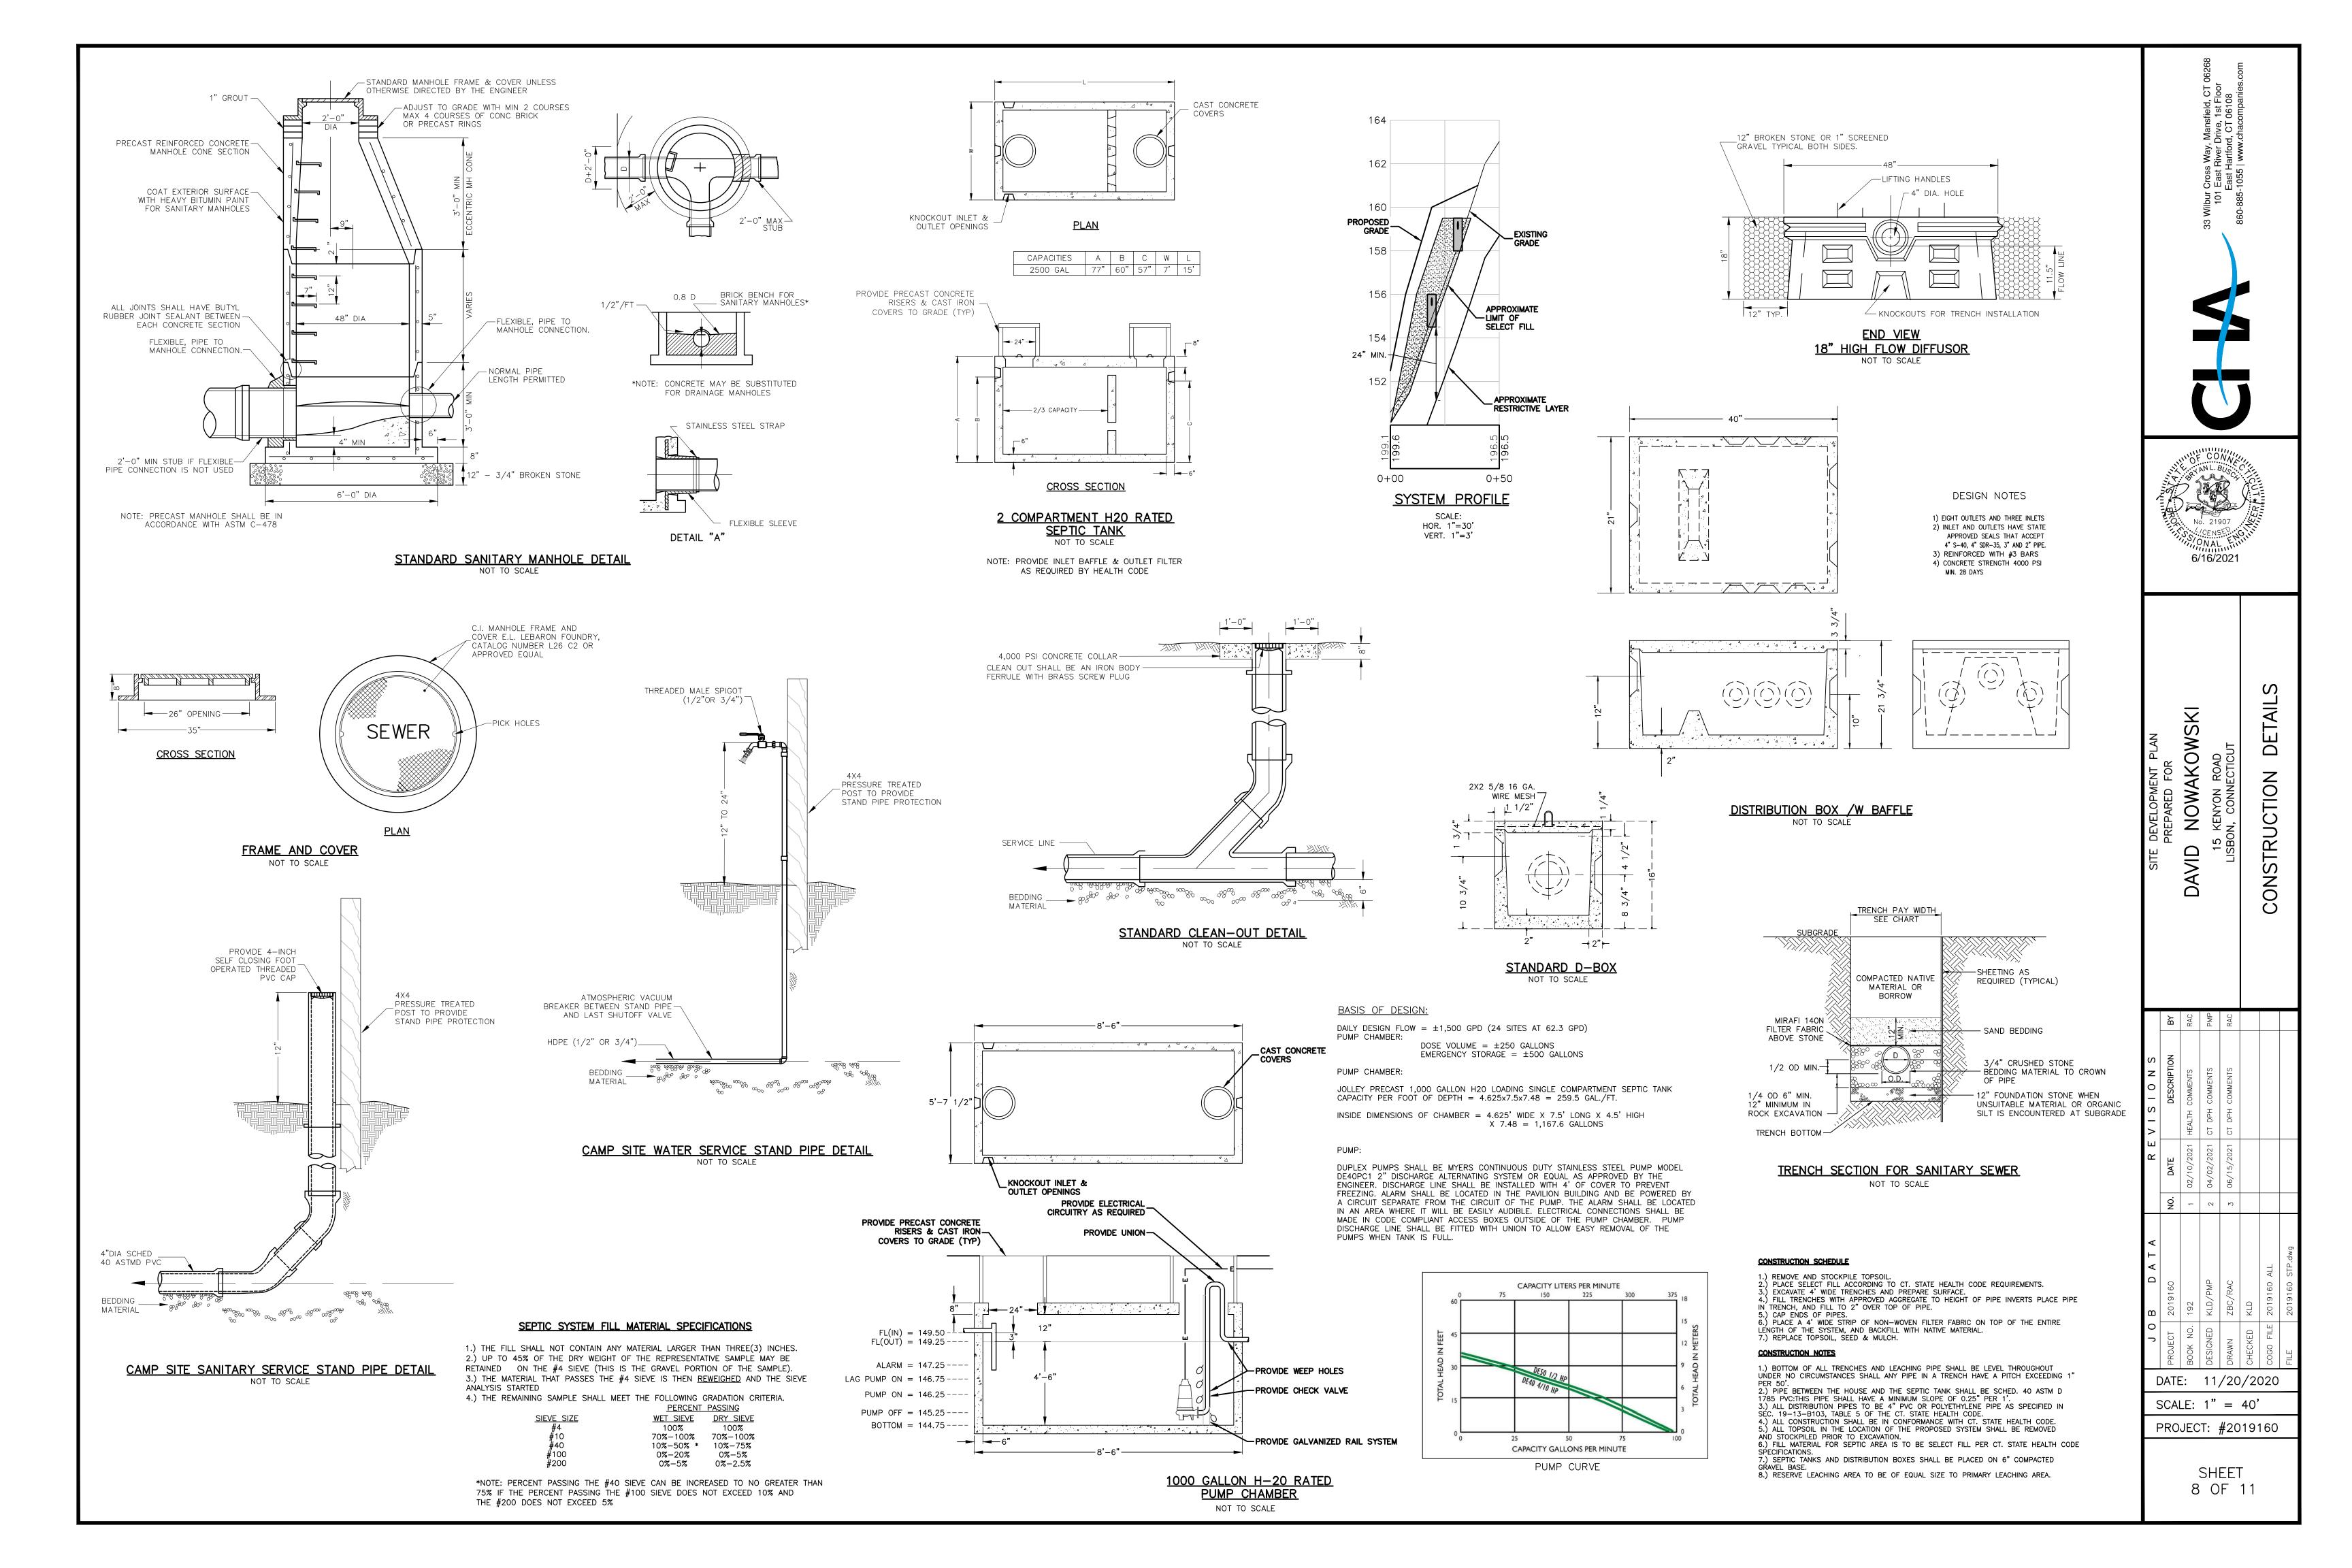

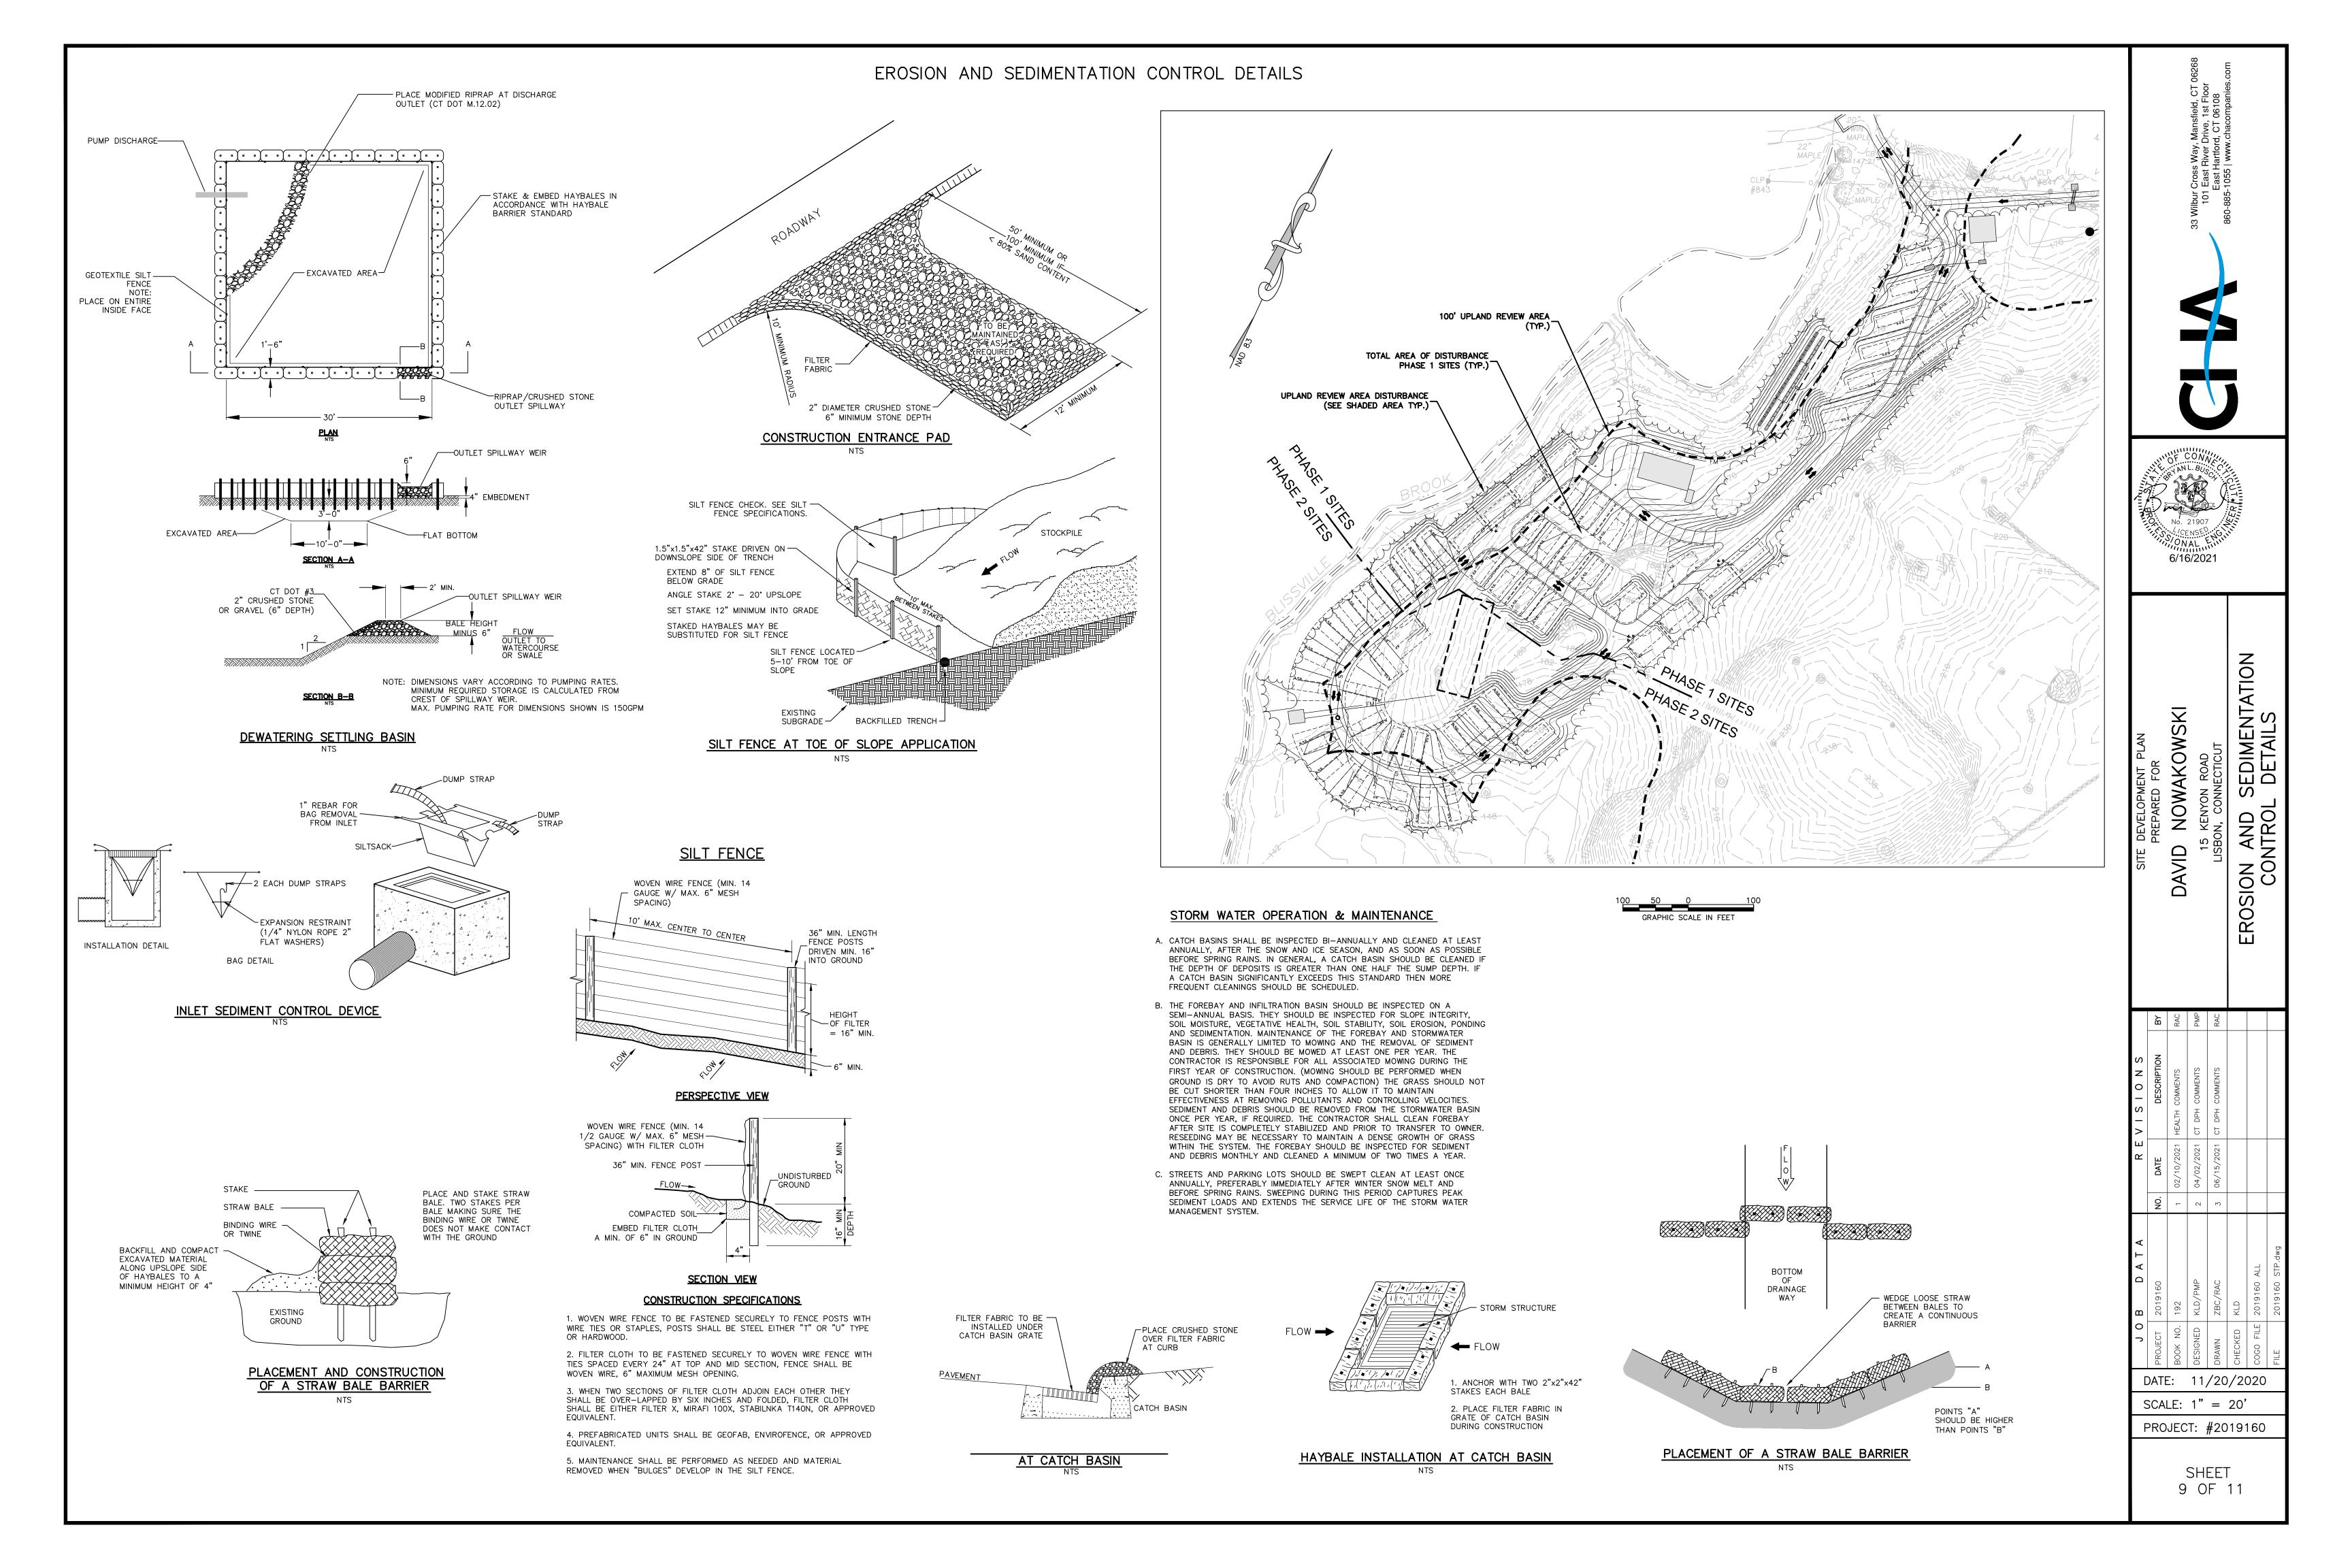

EROSION AND SEDIMENTATION CONTROL NARRATIVE & NOTES

PROJECT NARRATIVE

THIS PROJECT CONSISTS OF THE CONSTRUCTION OF THIRTY TWO CAMP SITES WITH ASSOCIATED UTILITIES AND ACCESS ROAD IN LISBON, CONNECTICUT.

THIS PROJECT REQUIRES THE FOLLOWING PERMITS:

UNCAS HEALTH DISTRICT SSDS

THIS PROJECT REQUIRES THE APPROVAL OF THE FOLLOWING BOARDS/COMMISSIONS TOWN OF LISBON CONSERVATION COMMISSION TOWN OF LISBON PLANNING AND ZONING COMMISSION

ESTIMATED CONSTRUCTION SCHEDULE

- A. INSTALL EROSION AND SEDIMENT CONTROL SYSTEMS OCTOBER 2021
- B. ROUGH GRADE SITE OCTOBER DECEMBER 2021
- C. INSTALL UTILITIES AND SEPTIC SYSTEMS MARCH JUNE 2021
- D. CONSTRUCT ROADWAY **JULY 2022**
- F. FINISH GRADE SITE AUGUST OCTOBER 2022

PROJECT SEQUENCE

- A. STAKEOUT LIMIT OF DISTURBANCE.
- B. HOLD PRECONSTRUCTION MEETING.
- CONTACT "CALL BEFORE YOU DIG" AT 1-800-922-4455 (CT) OR CONTACT "DIG SAFE" AT 1-888-344-7233. (MA) TWO (2) WORKING DAYS PRIOR TO THE START
- D. INSTALL CONSTRUCTION ENTRANCE.
- E. INSTALL TOE OF SLOPE PERIMETER FILTER (SILT FENCE OR HAYBALES) DOWN GRADIENT FROM ALL AREAS OF LAND CLEARING AND CONSTRUCTION ACTIVITY.
- F. PERFORM ALL NECESSARY CLEARING AND GRUBBING OPERATIONS.
- G. EXCAVATE ALL STUMPS LOCATED AND REMOVE TO A STOCKPILE AREA TO BE
- H. STRIP AND STOCKPILE TOPSOIL IN AN APPROVED AREA AND SECURE WITH EROSION AND SEDIMENT CONTROLS.
- I. ROUGH GRADE PROPOSED ROADWAY.
- J. CONSTRUCT SEPTIC SYSTEM.
- K. GRADE CAMP SITES. L. INSTALL UTILITIES
- M. INSTALL AND GRADE ROADWAY SUBBASE.
- N. INSTALL PROCESSED AGGREGATE IN CAMP SITES
- O. FINISH GRADE ROADWAY.
- P. COMPLETE THE BALANCE OF SITE WORK AND STABILIZATION OF ALL OTHER DISTURBED AREAS.
- P. REMOVE TEMPORARY EROSION AND SEDIMENT CONTROLS.

NOTE: SEVERAL OF THE ABOVE ACTIVITIES MAY BE DONE SIMULTANEOUSLY.

SEEDING SPECIFICATIONS

- A. IF GROUND HAS BEEN PREVIOUSLY MULCHED, MULCH MUST BE REMOVED OR ADDITIONAL NITROGEN MUST BE ADDED.
- B. REMOVE ALL SURFACE STONES 2" OR LARGER AS WELL AS ALL DEBRIS SUCH AS WIRE, CABLE, TREE ROOTS, PIECES OF CONCRETE, CLODS, CLUMPS, OR OTHER
- C. APPLY FERTILIZER AT 7.5 POUNDS PER 1,000 SQUARE FEET AND LIME AT 200 POUNDS PER 1,000 SQUARE FEET UNLESS SOIL TESTING FOR REQUIREMENTS IS PERFORMED.
- D. NO MOWING IS TO BE UNDERTAKEN UNTIL THE MAJORITY OF THE VEGETATION IS AT LEAST 6" HIGH. MOWING SHOULD CUT THE TOP 1/3 OF VEGETATION. DO NOT UNDER ANY CIRCUMSTANCES CUT VEGETATION BELOW 3".
- E. DO NOT APPLY ANY FORM OF WEED CONTROL UNTIL GRASS HAS BEEN MOWED
- F. THESE SEEDING MEASURES ARE NOT TO BE USED ON SLOPES IN EXCESS OF 2:1 GRADING.
- G. PERMANENT SEEDING MEASURES ARE TO BE USED INSTEAD OF TEMPORARY SEEDING MEASURES WHERE WORK IS TO BE SUSPENDED FOR A PERIOD OF TIME
- H. IF THERE IS NO EROSION, BUT SEED SURVIVAL IS LESS THAN 100 PLANTS PER SQUARE FOOT AFTER 4 WEEKS OF GROWTH, RE-SEED AS PLANTING SEASON
- I. ALL DISTURBED AREAS OUTSIDE THE PAVEMENT AREA, WITHIN AND OUTSIDE THE ROAD RIGHT OF WAY, SHALL BE RESTORED IN ACCORDANCE WITH THE CITY/TOWN SUBDIVISION REGULATIONS.

EROSION & SEDIMENT CONTROL OPERATIONS AND MAINTENANCE

- A. EROSION AND SEDIMENTATION CONTROL AND RESTORATION MEASURES SHALL CONFORM TO THE "2002 CONNECTICUT GUIDELINES FOR SOIL EROSION AND SEDIMENTATION CONTROL", PUBLISHED BY THE CONNECTICUT COUNCIL OF SOIL AND WATER CONSERVATION AND THE CONNECTICUT DEPARTMENT OF ENVIRONMENTAL PROTECTION AND TO TOWN REGULATIONS.
- B. INSTALLATION OF SEDIMENT AND EROSION CONTROLS SUCH AS HAYBALES AND SILT FENCES SHALL BE ESTABLISHED PRIOR TO COMMENCING ANY LAND DISTURBANCE ACTIVITIES.
- C. ALL STOCKPILED MATERIAL SHALL BE RINGED WITH HAYBALES OR SILT FENCES. ANY MATERIAL TO BE STOCKPILED LONGER THAN 14 DAYS SHALL BE STABILIZED WITH TEMPORARY SEEDING OR JUTE NETTING.
- D. HAYBALE FILTERS OR SILT FENCE SHALL BE PLACED 5-10 FEET FROM THE TOE OF ALL CRITICAL SLOPES AS SHOWN ON THE PLAN. THESE SHALL BE CHECKED BY THE CONTRACTOR REGULARLY AND REPAIRED WHENEVER THEY FAIL TO INSURE CLEAN RUN-OFF FROM THE SITE.
- E. ADDITIONAL CONTROL MEASURES IF REQUESTED BY THE TOWN SHALL BE INSTALLED IMMEDIATELY UPON REQUEST.
- F. ALL DISTURBED AREAS SHALL BE PROTECTED WITH A MINIMUM VEGETATION COVER AS SHOWN IN ACCOMPANYING CHART.
- G. THE CONTRACTOR SHALL PLAN ALL LAND DISTURBING ACTIVITIES IN A MANNER AS TO MINIMIZE THE EXTENT OF THE DISTURBED AREAS.
- H. THE CONTRACTOR SHALL MAKE DAILY INSPECTIONS OF THE SITE TO INSURE EFFECTIVENESS OF EROSION AND SEDIMENTATION CONTROL MEASURES AND WILL IMMEDIATELY MAKE NECESSARY REPAIRS IF REQUIRED BY THE CITY/TOWN.
- I. ALL EROSION AND SEDIMENT CONTROL MEASURES ARE TO BE INSPECTED AT A MINIMUM OF ONCE A WEEK AND WITHIN 24 HOURS OF THE END OF A STORM WITH A RAINFALL AMOUNT OF 0.1 INCHES OR GREATER TO DETERMINE MAINTENANCE NEEDS.
- J. ALL EROSION AND SEDIMENT CONTROL MEASURES ARE TO BE REPLACED WITHIN 24 HOURS OF AN OBSERVED FAILURE.
- K. ALL CONSTRUCTION TRAFFIC SHALL ENTER AND LEAVE BY THE DESIGNATED ENTRANCE. THIS ENTRANCE SHALL BE CONSTRUCTED OF CRUSHED STONE TO HELP FREE TIRES OF SOIL WHEN LEAVING THE SITE. THE CONTRACTOR SHALL INSTRUCT ALL VEHICLE DRIVERS TO CLEAN SOIL MATERIAL FROM TIRES IN FRONT OF THE SITE. ALL SOIL, MISCELLANEOUS DEBRIS, OR OTHER MATERIAL SPILLED, DUMPED OR OTHERWISE DEPOSITED ON PUBLIC STREETS, HIGHWAYS, SIDEWALKS OR OTHER PUBLIC THOROUGHFARES DURING TRANSIT TO OR FROM THE SITE SHALL BE REMOVED PROMPTLY.
- O. THE CONTRACTOR HEREBY ACKNOWLEDGES HIS RESPONSIBILITY TO INSTALL SOIL EROSION AND SEDIMENTATION CONTROL MEASURES ON THIS SITE AND THAT HIS FAILURE TO INSTALL AND MAINTAIN THESE DEVICES COULD RESULT IN FINES OR SUSPENSION OF WORK BY THE CITY/TOWN.

A. ALL HAYBALES SHALL BE EITHER WIRE OR STRING BOUND. HAYBALES SHALL BE

B. GAPS BETWEEN HAYBALES SHALL BE CHINKED WITH STRAW TO PREVENT WATER

C. ON SLOPES WHERE SURFACE FLOW FOLLOWS THE HAYBALE LINE, PERPENDICULAR

AND EROSION PROTECTION IS REQUIRED FOR A PERIOD OF TIME LONGER THAN 3

GRADIENT FROM THE SLOPE. WHERE CONTOUR LINES CAN NOT BE FOLLOWED HAYBALES SHOULD BE STAGGERED AND PERPENDICULAR WINGS SHOULD BE

D. HAYBALES SHOULD NEVER BE USED FOR ANY APPLICATION WHERE SEDIMENT

E. HAYBALES SHOULD HAVE A MINIMUM WEIGHT OF 40 POUNDS AND A MAXIMUM

G. HAYBALES SHOULD BE PLACED IN AN EXCAVATED TRENCH AT LEAST 4" DEEP.

H. HAYBALE STAKES ARE TO BE MADE OUT OF HARDWOOD WITH A MINIMUM CROSS SECTIONAL AREA OF 1.5 SQUARE INCHES OR STEEL POSTS WITH A MINIMUM

A. SYNTHETIC FILTER FABRIC SHALL BE A PERVIOUS SHEET OF PROPYLENE, NYLON,

POLYESTER, ETHYLENE, OR SIMILAR FILAMENTS AND SHALL BE CERTIFIED BY THE MANUFACTURER OR SUPPLIER AS CONFORMING TO THE FOLLOWING MINIMUM

75 PERCENT (MIN)

250 POUNDS PER SQUARE INCH

0.2 GALLONS PER SQUARE FOOT PER

100 POUNDS

15 PERCENT

50 POUNDS

MINUTE

9. ULTRAVIOLET RADIATION STABILITY 70 PERCENT AFTER 500 HOURS OF

STAKES ARE TO BE MADE OUT OF HARDWOOD WITH A MINIMUM CROSS SECTIONAL AREA OF 1.5 SQUARE INCHES OR STEEL POSTS WITH A MINIMUM

ON SLOPES WHERE SURFACE FLOW FOLLOWS THE SILT FENCE LINE,

PERPENDICULAR SILT FENCE CHECKS SHALL BE INSTALLED AT 50 FOOT

LINES OF SILT FENCE SHOULD FOLLOW CONTOUR LINES 5-10 FEET DOWN GRADIENT FROM THE SLOPE. WHERE CONTOUR LINES CAN NOT BE FOLLOWED

PERPENDICULAR WINGS SHOULD BE PLACED AT 50 FOOT INTERVALS.

0.60mm< X <0.90mm

0.05 PER SECOND (MIN)

EXPOSURE (MIN)

F. LINES OF HAYBALES SHOULD FOLLOW CONTOUR LINES 5-10 FEET DOWN

HAYBALE CHECKS SHALL BE INSTALLED AT 50 FOOT INTERVALS.

ALONG THE TOP AND BOTTOM OF THE BALES TO PREVENT DETERIORATION OF

P. MINIMIZE OR ELIMINATE ANY UNNECESSARY LAND DISTURBANCE OR CLEARING.

HAYBALE SPECIFICATIONS

FROM ESCAPING BETWEEN BALES.

WEIGHT OF 120 POUNDS.

PLACED AT 50 FOOT INTERVALS.

SILT FENCE SPECIFICATIONS

1. FILTERING EFFICIENCY

2. GRAB TENSILE STRENGTH

3. ELONGATION AT FAILURE

4. MULLEN BURST STRENGTH

6. APPARENT OPENING SIZE

WEIGHT OF 0.5 POUNDS PER LINEAR FOOT.

C. TORN OR PUNCTURED GEOTEXTILES SHALL NOT BE USED.

5. PUNCTURE STRENGTH

REQUIREMENTS:

7. FLOW RATE

8. PERMITTIVITY

WEIGHT OF 0.5 POUNDS PER LINEAR FOOT.

THE BINDINGS.

GENERAL NOTES

- 1. ALL UTILITIES SHALL BE APPROVED BY LOCAL UTILITY COMPANIES PRIOR TO CONSTRUCTION; ALL UTILITIES SHALL BE CONSTRUCTED TO UTILITY COMPANY
- 3. NO CHANGES CAN BE MADE TO THESE PLANS WITHOUT THE DESIGN ENGINEER'S APPROVAL. FIELD CHANGES SHALL HAVE PRIOR APPROVAL OF THE ENGINEER.
- 4. CONTRACTOR SHALL NOTIFY THE DESIGN ENGINEER OF CONSTRUCTION SCHEDULE SO THAT INSPECTION MAY BE PROVIDED.
- 6. UNDERGROUND UTILITY, STRUCTURE AND FACILITY LOCATIONS DEPICTED ON PLANS HAVE BEEN COMPILED, IN PART, FROM RECORD MAPPING SUPPLIED BY THE RESPECTIVE UTILITY COMPANIES OR GOVERNMENTAL AGENCIES, FROM PAROLE TESTIMONY, FIELD MEASUREMENTS AND FROM OTHER SOURCES. THESE LOCATIONS MUST BE CONSIDERED APPROXIMATE IN NATURE. ADDITIONALLY, OTHER SUCH FEATURES MAY EXIST ON THE SITE, THE EXISTENCE OF WHICH ARE UNKNOWN TO
- 7. CONTACT "CALL BEFORE YOU DIG" AT 1-800-922-4455 (CT) OR CONTACT "DIG SAFE" AT 1-888-344-7233. (MA) TWO (2) WORKING DAYS PRIOR TO THE START OF

SUGGESTED SEEDING MIXTURES AND PRACTICES

AREAS WHERE SEED MIX APPLIES	SEEDING MIXTURES BY WEIG	GHT	RATE PER 1,000 SQ. FT.	SEEDING DATES
ALL LAWN AREAS	RED FESCUES KENTUCKY BLUEGRASS PERENNIAL RYEGRASS	45% 45% 10%	1 LBS.	APRIL 1 — JUNE 15 OR AUG. 15 — OCT. 1
ROAD CUTS, FILLS, DIVERSION DITCHES, & STORMWATER BASINS	KENTUCKY TALL FESCUE REDTOP CREEPING RED FESCUE	47% 6% 47%	0.95 LBS.	APRIL 1 — JUNE 15 OR AUG. 15 — OCT. 1

WHERE TREES ARE TO BE RETAINED, THE SEED MIXTURE SHOULD BE ADAPTED FOR SHADY CONDITIONS.

TEMPORARY SEEDING	ANNUAL RYEGRASS OR PERENNIAL RYEGRASS	1-1/2 LBS.	WITHIN 7 DAYS AFTER SUSPENSION OF GRADING WORK

PERSON RESPONSIBLE FOR MAINTAINING CONTROL MEASURES DURING CONSTRUCTION. DAVID NOWAKOWSKI

ADDRESS <u>(860)-376-1081</u> TELEPHONE #

LOCATION	DESCRIPTION	DATE	INITIALS
PROJECT DATES		DATE	INITIALS
ROJECT GROUNDBF	PEAKING		

- 2. ALL CONSTRUCTION SHALL BE TO TOWN SPECIFICATIONS & REGULATIONS.
- CHA COMPANIES. THE SIZE, LOCATION AND EXISTENCE OF ALL SUCH FEATURES MUST BE FIELD DETERMINED AND VERIFIED BY THE APPROPRIATE AUTHORITIES PRIOR TO

15 KENYON ROAD, LISBON, CT

MAINTENANCE LOC

DATE: 11/20/2020 SCALE: AS NOTED


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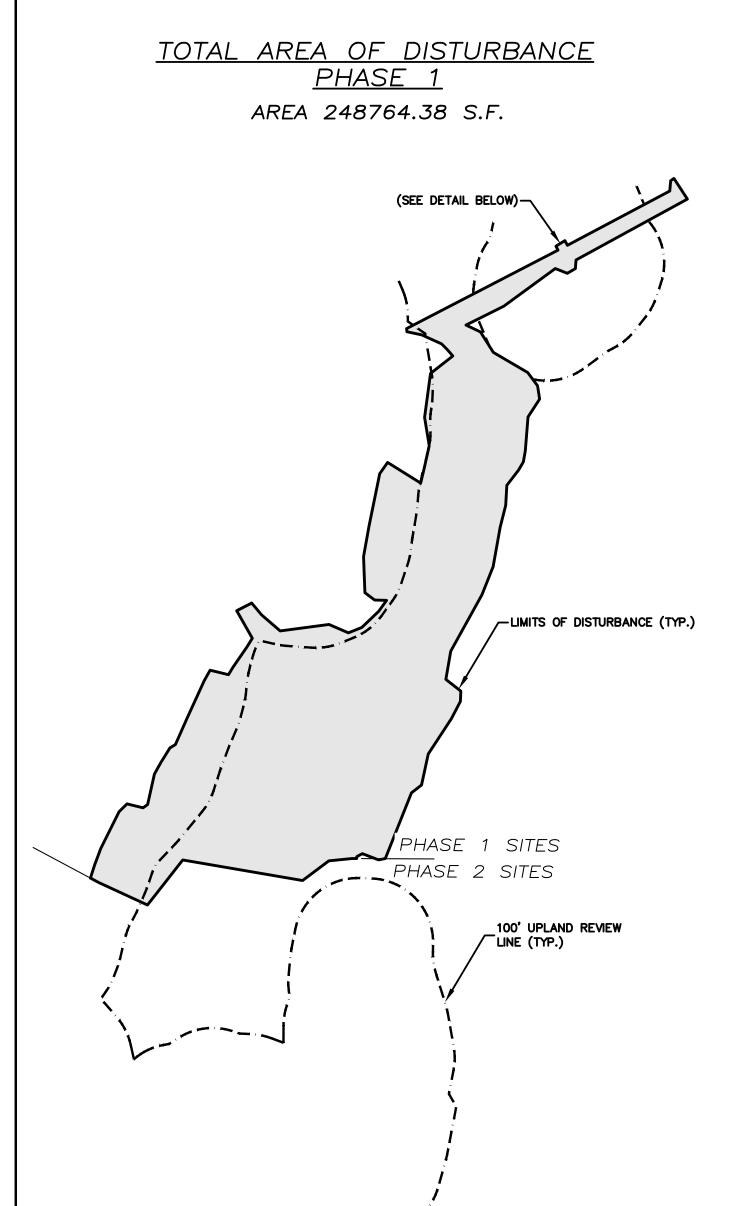
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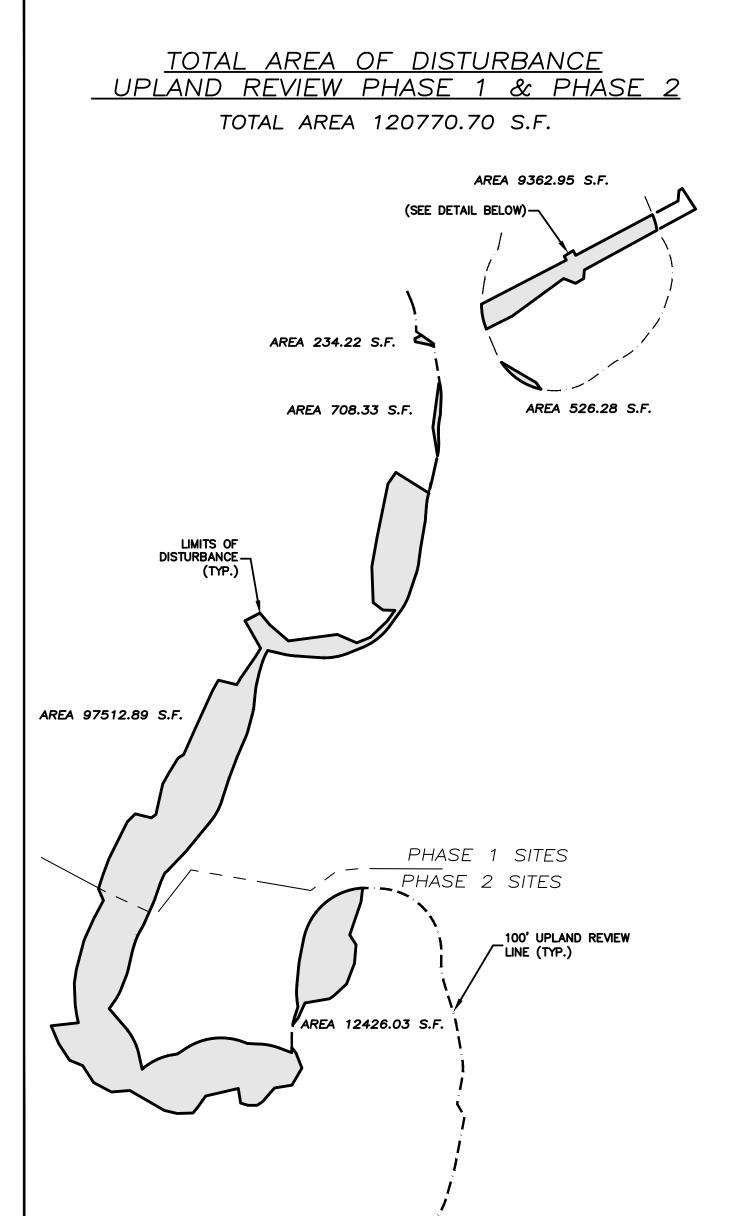
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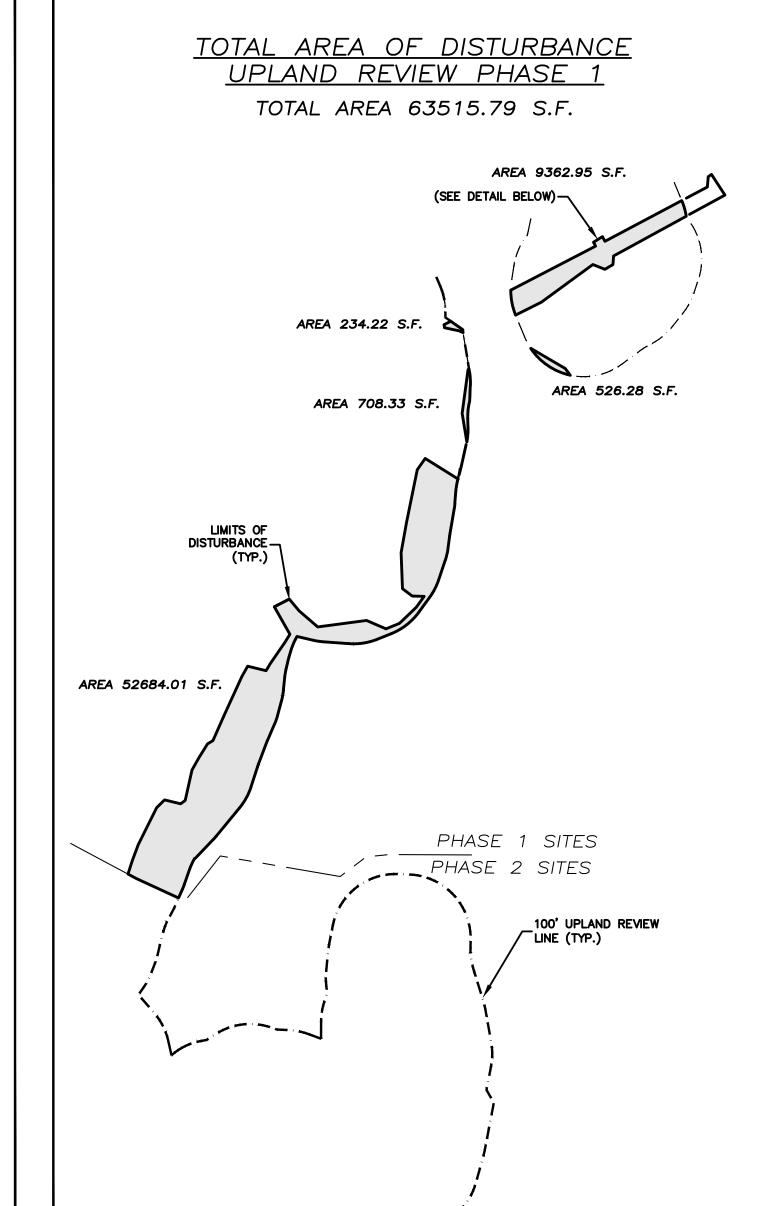
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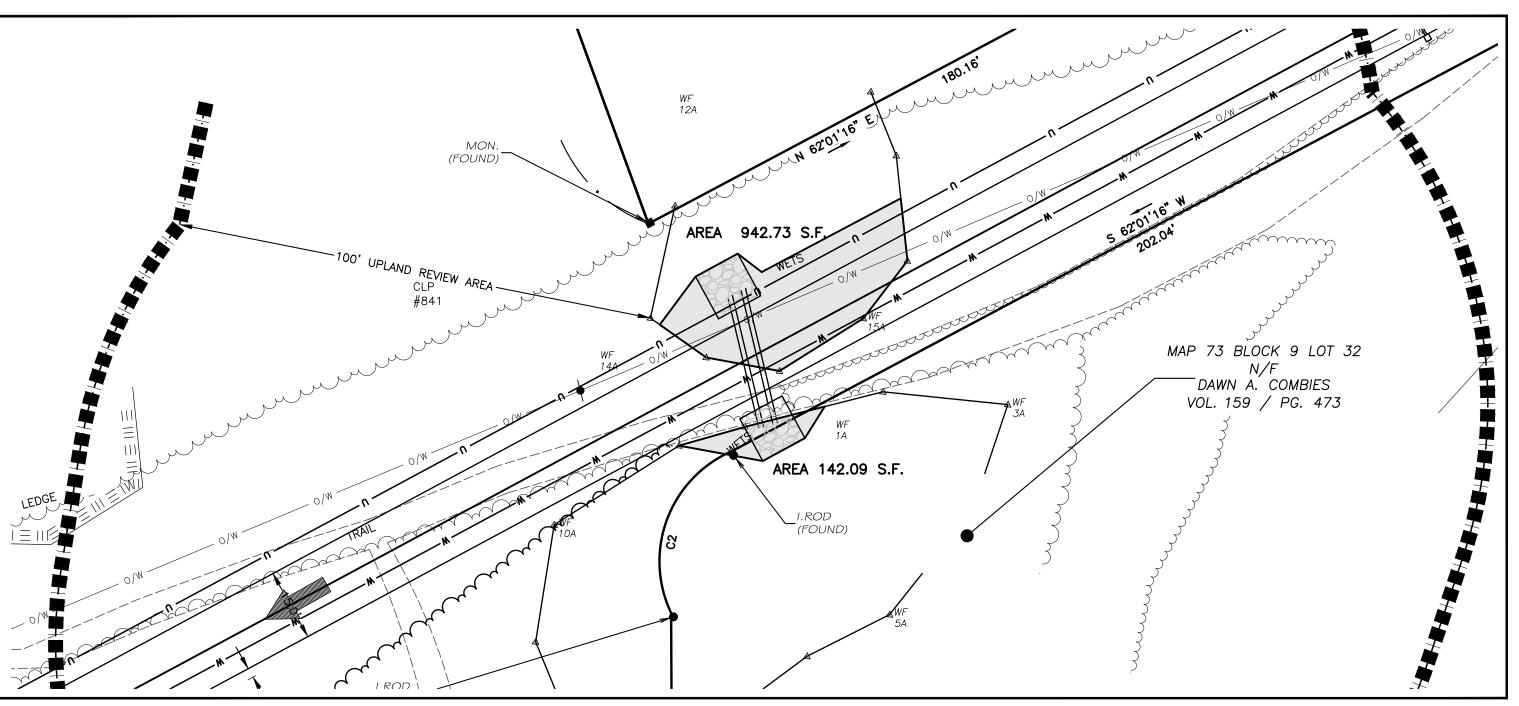
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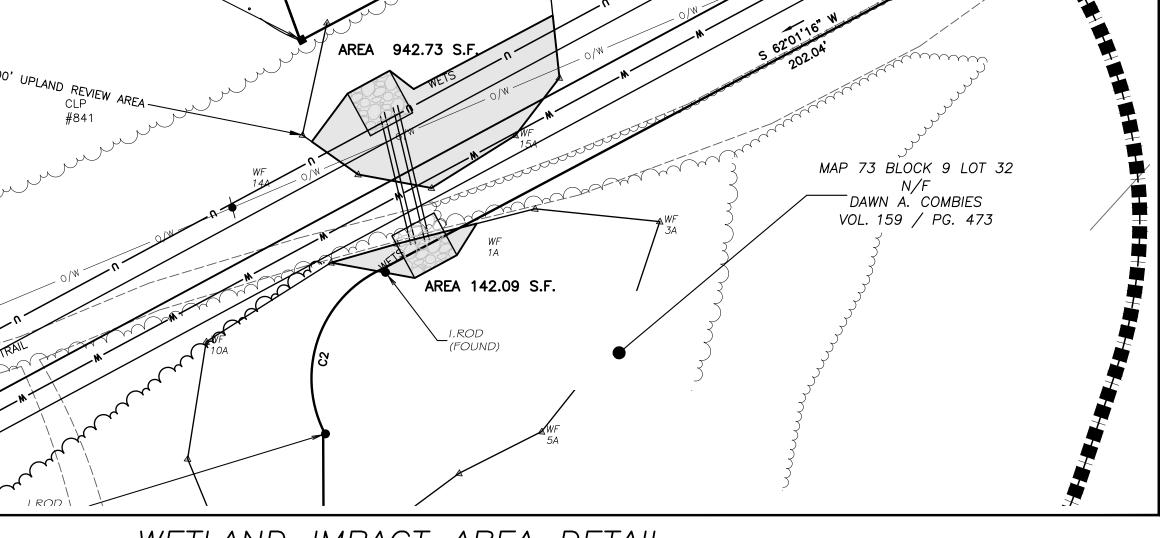











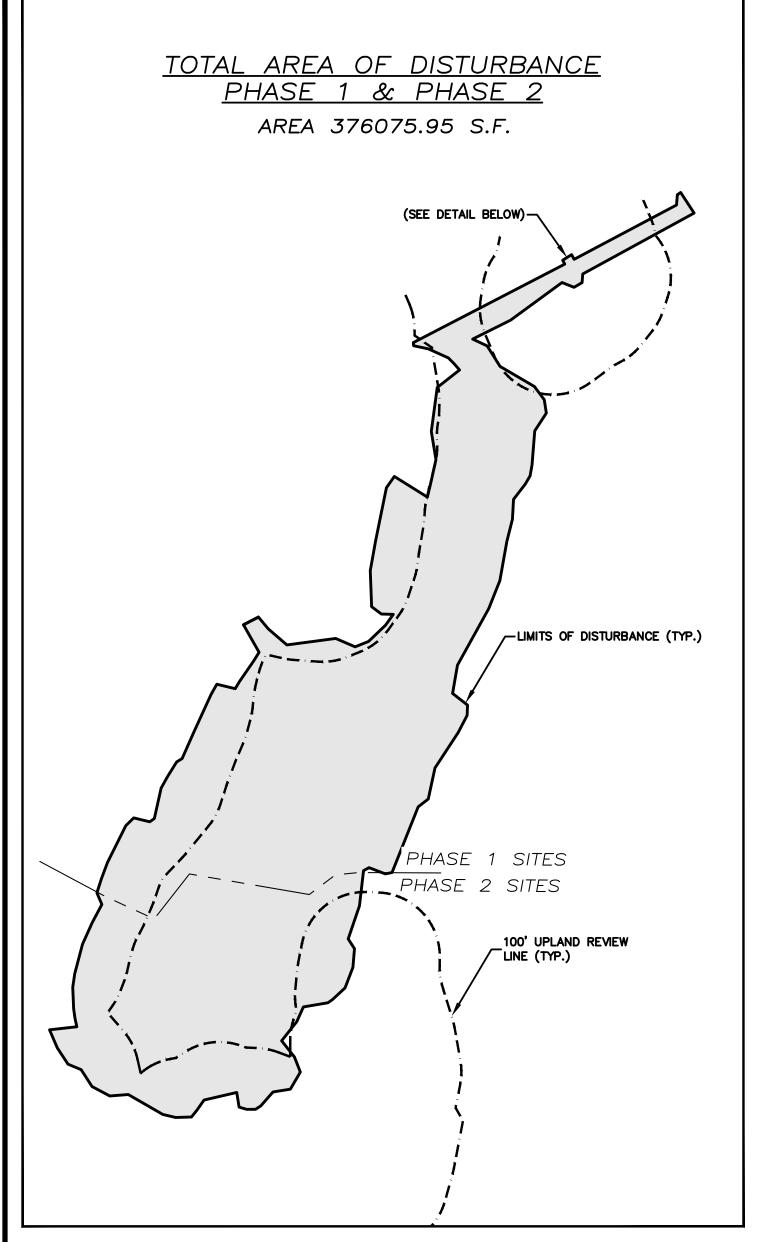

WETLAND IMPACT AREA DETAIL

TOTAL AREA 1084.82 S.F.

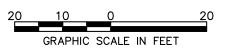

<u>LEGEND</u>	
PROPERTY LINE	
ABUTTERS LINE	
EDGE OF PAVEMENT	
EDGE OF GRAVEL	
EXISTING CONTOUR	——————————————————————————————————————
STONE WALL	
RETAINING WALL	
LIMITS OF INLAND WETLANDS	
FENCE	X X X
PROPOSED SILT FENCE	
TREE LINE	
PROP UNDERGROUND WATER	
PROP UNDERGROUND ELECTRIC	——— E ———
PROP UNDERGROUND CABLE/TV	тт
PROP UNDERGROUND FUTURE UTILITY	U
FLOOD ZONE LIIMIT	
100' UPLAND REVIEW LINE	
NOW OR FORMERLY	N/F
UTILITY POLE	· · · · ·
BOUNDARY POINT	©
IRON MONUMENT	•
STONE MONUMENT	Ē
TEST PIT	-

PERC HOLE

DATE: 11/20/2020

SCALE: 1" = 80'

PROJECT: #2019160

SHEET 11 OF 11